
At LOT 09 (No 15) CALIMO PLACE **INTENDED HEADS, VIC., 3223**

Drawing Name

A00	COVER
A01	GENERAL NOTES
A02	SITE PLAN
A03	SETOUT PLAN
A04	GROUND LEVEL FLOOR PLAN
A05	FIRST LEVEL FLOOR PLAN
A06	ELEVATIONS
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80A	GROUND FLOOR REFLECTED CEILING PLAN
A09	FIRST FLOOR REFLECTED CEILING PLAN
A10	GROUND FLOOR ELECTRICAL PLAN
A11	FIRST FLOOR ELECTRICAL PLAN
A12	ROOF PLAN
A13	SECTION 1/1
A14	SECTION 2/1
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A19	DOOR SCHEDULE 1/3
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A25	INTERIORS KITCHEN
A26	INTERIORS PANTRY/STUDY
A27	INTERIORS ENS/WC/TV
A28	INTERIORS BATH/PWD/BOAT
A29	INTERIORS ROBES/LINEN
A30	INTERIORS LAUNDRY/WET ROOM
A31	INTERIORS LIVING/RUMPUS/BBQ
A32	STAIR DETAILS - MAIN
A33	STAIR DETAILS - REAR
A34	SHADOW ANALYSIS
A35	OVERLOOKING DIAGRAMS

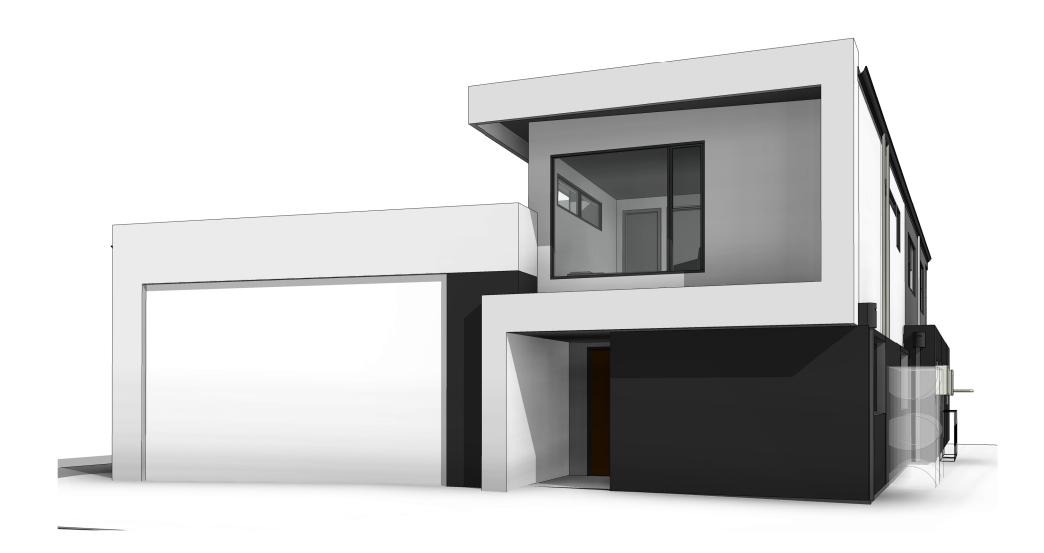

NOTES ORIGINAL A3

DO NOT SCALE DRAWINGS - REFER ONLY TO WRITTEN DIMESIONS

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Н	08.10.19	LIGHT POLE	ALT	AR
	01.11.19	BUILDING ENVELOPE	ALT	AR
J	11.11.19	FLOOR SET DOWN	ALT	AR

CLIENT

BRENDAN PETER BORG

PROJECT

LOT 09 (No. 15) CALIMO PLACE INDENTED HEAD 3223

DRAWING

COVER

Derbyshire

DRAWN	CHECKED	SCALE
ALT	AR	N/A
DATE	PROJECT No	STATUS
1.11.2019	G1811	CD
DRAWING No		REV
A00		

GENERAL NOTES

BUILDING REGULATIONS 2018

ALL MATERIALS AND WORK PRACTICES SHALL COMPLY WITH, BUT NOT LIMITED TO THE BUILDING REGULATIONS 2006, NATIONAL CONSTRUCTION CODE SERIES 2019 BUILDING CODE OF AUSTRALIA VOL 2 AND ALL RELEVANT CURRENT AUSTRALIAN STANDARDS (AS AMENDED) REFERRED TO THEREIN, UNLESS OTHERWISE SPECIFIED, THE TERM NCC SHALL REFER TO NATIONAL CONSTRUCTION CODE SERIES 2019 BUILDING CODE OF AUSTRALIA VOLUME 2. ALL MATERIALS AND CONSTRUCTION PRACTICE SHALL MEET THE PERFORMANCE REQUIREMENTS OF THE NCC. WHERE AN ALTERNATIVE SOLUTION IS PROPOSED THEN, PRIOR TO IMPLEMENTATION OR INSTALLATION, IT FIRST MUST BE ASSESSED AND APPROVED BY THE RELEVANT BUILDING SURVEYOR AS

THESE DRAWINGS SHALL BE READ IN CONJUNCTION WITH ANY HOUSE ENERGY RATING (HERS) REPORT AND SHALL BE CONSTRUCTED IN ACCORDANCE WITH THE STAMPED PLANS ENDORSED BY THE ACCREDITED THERMAL PERFORMANCE ASSESSOR WITHOUT ALTERATION

MEETING THE PERFORMANCE REQUIREMENTS OF THE NCC.

INSTALLATION OF ALL SERVICES SHALL COMPLY WITH THE RESPECTIVE SUPPLY AUTHORITY REQUIREMENTS.

DO NOT SCALE PLANS, USE WRITTEN DIMENSIONS ONLY. FIGURED DIMENSIONS TAKE PRECEDENCE OVER SCALED DIMENSIONS.

THE OWNER, BUILDER, SUBCONTRACTOR SHALL VERIFY ALL DIMENSIONS, LEVELS, SETBACKS AND SPECIFICATIONS PRIOR TO COMMENCING ANY WORKS OR ORDERING MATERIALS AND SHALL BE RESPONSIBLE FOR ENSURING THAT ALL BUILDING WORKS CONFORM TO THE BUILDING CODE OF AUSTRALIA, AS CODES (CURRENT EDITIONS), BUILDING REGULATIONS, LOCAL BY-LAWS AND TOWN PLANNING REQUIREMENTS. REPORT ALL DISCREPANCIES TO THIS OFFICE

ALL WORKS SHALL COMPLY WITH BUT NOT LIMITED TO THE FOLLOWING AUSTRALIAN STANDARDS: AS 1288 - GLASS IN BUILDINGS – SELECTION AND

NOITA LIATION AS 1562 - DESIGN AND INSTALLATION OF SHEET ROOF AND

WALL CLADDING
AS 1684 - RESIDENTIAL TIMBER FRAMED CONSTRUCTION

AS 1860 - INSTALLATION OF PARTICLE BOARD FLOORING AS 2047 - INSTALLATION AND SELECTION OF WINDOWS AS 2049 - ROOF TILES

AS 2050 - FIXING OF ROOF TILES AS 2870 - RESIDENTIAL SLARS AND FOOTINGS

AS 2904 - DAMP PROOF COURSES AND FLASHINGS

AS 3500 - PLUMBING & DRAINAGE AS 3600 - CONCRETE STRUCTURES AS 3660 - PROTECTION OF BUILDINGS FROM SUBTERRANEAN

TERMITES

AS 3700 - MASONRY IN BUILDINGS.

AS 3740 - WATERPROOFING OF WET AREAS IN RESIDENTIAL BUILDINGS AS 3959 - CONSTRUCTION IN A BUSHFIRE PRONE AREA

AS 3786 - SMOKE ALARMS

AS 4055 - WIND LOADINGS FOR HOUSING

AS 4100 - STEEL STRUCTURES

THESE PLANS SHALL BE READ IN CONJUNCTION WITH ANY STRUCTURAL OR CIVIL ENGINEERING COMPUTATIONS AND DRAWINGS; AND ALL OTHER CONSULTANTS DRAWINGS /DETAILS AND WITH ANY OTHER WRITTEN INSTRUCTIONS ISSUED IN THE COURSE OF THE CONTRACT.

WHERE REQUIRED TREAT AREA BENEATH FLOOR AGAINST TERMITE INFESTATION IN ACCORDANCE WITH RELEVANT STANDARD. CONTACT THE RELEVANT MUNICIPAL COUNCIL TO DETERMINE IF THIS IS MANDATORY

GLAZING, INCLUDING SAFETY GLAZING, SHALL BE INSTALLED TO A SIZE, TYPE AND THICKNESS SO AS TO COMPLY WITH: NCC PART 3 FOR CLASS 1 AND 10 BUILDINGS WITHIN A DESIGN WIND SPEED OF NOT MORE THAN N3; AND - NCC 2019 BCA VOL 1 PART B1.4 FOR CLASS 2 AND 9 BUILDINGS. SAFETY GLASS TO BE LISED IN THE FOLLOWING CASES: I) ALL ROOMS – WITHIN 500mm VERTICAL OF THE FLOOR. II) BATHROOMS – WITHIN 2000mm OF THE FLOOR.
III) LAUNDRY – WITHIN 1200mm VERTICAL FROM FLOOR AND/OR WITHIN 300mm HORIZONTAL FROM ALL DOORS. IV) DOORWAY - WITHIN 300mm HORIZONTAL FROM DOORS SHOWER SCREENS SHALL BE GRADE A SAFETY GLASS.

WINDOW SIZES ARE NOMINAL ONLY, ACTUAL SIZE WILL VARY ACCORDING TO MANUFACTURER, WINDOWS TO BE FLASHED ALL AROUND.

STORM WATER SHALL BE TAKEN TO LEGAL POINT OF DISCHARGE AS ADVISED BY THE MUNICIPAL DRAINAGE ENGINEER. CONTACT THE COUNCIL IF UNSURE OF POINT OF DISCHARGE. 90 DIA. CLASS 6 UPVC STORMWATER LINE LAID TO A MINIMUM GRADE OF 1:100. PROVIDE INSPECTION OPENINGS AT 9000MM C/C AND AT EACH CHANGE OF DIRECTION. THE COVER TO UNDERGROUND STORMWATER DRAINS SHALL BE NOT LESS THAN:

- 100MM UNDER SOIL
- 50MM UNDER PAVED OR CONCRETE AREAS 100MM UNDER UN-REINFORCED CONCRETE OR PAVED
- DRIVEWAYS
- 75MM UNDER REINFORCED CONCRETE DRIVEWAYS

N12: THE BUILDER AND SUBCONTRACTOR SHALL ENSURE THAT ALL STORMWATER DRAINS, SEWER PIPES, AND THE LIKE ARE LOCATED AT A SUFFICIENT DISTANCE FROM ANY BUILDINGS FOOTING AND/OR SLAB EDGE BEAMS SO AS TO PREVENT GENERAL MOISTURE PENETRATION, DAMPNESS, WEAKENING AND UNDERMINING OF ANY BUILDING AND IT'S FOOTING

SEWER OR SEPTIC SYSTEM SHALL BE IN ACCORDANCE WITH THE RELEVANT AUTHORITIES REQUIREMENTS.

N14: FOOTINGS NOT TO ENCROACH TITLE BOUNDARIES AND EASEMENT LINES. OWNER AND BUILDER TO ENSURE THIS DOES NOT OCCUR.

FOR BUILDINGS IN CLOSE PROXIMITY TO THE BEACH ENSURE THAT ALL STEEL WORK, BRICK CAVITY TIES AND STEEL LINTELS, ETC THAT ARE IMBEDDED OR FIXED INTO MASONRY BE PROTECTED IN ACCORDANCE WITH AS 3700 HOT DIPPED

N16: ALL WET AREAS TO COMPLY WITH AS 3740, WALL FINISHES SHALL BE IMPERVIOUS TO A HEIGHT OF 1800mm ABOVE FLOOR LEVEL TO SHOWER ENCLOSURES AND 300mm ABOVE BATHS, BASINS, SINKS AND TROUGHS IF WITHIN 75mm OF THE WALL. REFER TO CODE FOR ALL REQUIREMENTS.

PROVIDE WALL TIES TO BRICKWORK AT MAXIMUM 600mm CRS IN EACH DIRECTION AND WITHIN 300mm OF ARTICULATION

N18: SUB FLOOR VENTS ARE TO PROVIDE A RATE OF 7500mm SQ CLEAR VENTILATION PER 1000mm RUN OF EXTERNAL WALL AND 2200mm SQ CLEAR VENTILATION PER 1000mm RUN OF INTERNAL DWARF WALLS. (LOCATED BELOW BFARFR)

PROVIDE CLEARANCE FROM UNDERSIDE OF BEARERS TO FINISHED GROUND LEVEL OF 150mm FOR FLOOR WITH STRIP FLOORING OR 200mm FOR FLOORS WITH PARTICLEBOARD FLOORING AND 400mm IN A TERMITE DECLARED AREA.

N20: NEW DWELLINGS, TO COMPLY WITH A 6 STAR ENERGY RATING REPORT (H.E.R.S.)

N21: STAIR REQUIREMENTS: RISERS – 190mm MAXIMUM - 115mm MINIMUM. GOING - 355mm MAXIMUM - 240mm MINIMUM (DOMESTIC ONLY)

RISERS AND TREADS TO BE CONSTANT IN SIZE THROUGHOUT FLIGHT. PROVIDE NON-SLIP FINISH OR SUITABLE NON-SKID STRIP NEAR EDGE OF NOSING'S. PROVIDE CONTINUOUS HANDRAIL 1000mm MINIMUM HEIGHT TO BALCONIES AND DECKS WHICH ARE 1000mm OR MORE ABOVE GROUND LEVEL. 865mm MINIMUM HEIGHT HANDRAIL ABOVE STAIR NOSING'S AND LANDINGS. MAXIMUM OPENINGS BETWEEN BALUSTERS NOT TO EXCEED 125mm AND MAXIMUM GAP TO OPEN TREAD NOT TO EXCEED 125mm

FOR WIRE BALUSTRADE SEE NCC VOLUME 2 REQUIREMENTS

N22: STUMPS EXCEEDING 1200mm ABOVE GROUND TO BE BRACED CONCRETE STUMPS

- 100mm SQ UP TO 1400mm LONG (1 No. HD. WIRE) 100mm SQ 1400mm TO 1800mm LONG (2 No. HD. WIRES)
- 125mm SQ 1800mm TO 3000mm LONG (2 No. HD. WIRES)

N23:THE BUILDER SHALL TAKE ALL STEPS NECESSARY TO ENSURE THE STABILITY OF NEW AND EXISTING STRUCTURES DURING ALL

N24: THE BUILDER SHALL ENSURE FOR THE GENERAL WATERTIGHTNESS OF ALL NEW AND EXISTING WORKS.

N25:SMOKE ALARMS TO BE PROVIDED AND INSTALLED IN ACCORDANCE WITH AS3786. NEW DWELLINGS AND ADDITIONS WITH SLEEPING ACCOMMODATION TO BE HARD

WHERE BUILDING IS WITHIN A DESIGNATED BUSHFIRE PRONE AREA COMPLIANCE WITH AS 3959 - IS REQUIRED TO A LEVEL OF ATTACK AS CONFIRMED BY THE RELEVANT BUILDING

N27:
W.C. DOORS TO TOILET PANS LOCATED WITHIN 1.2m OF THE DOOR JAMB LIFT OFF HINGES MUST BE FITTED. OTHERWISE THE DOORS MUST SWING OUTWARDS.

N28:TERMITE CERTIFICATE (WHERE REQUIRED) TO BE INSTALLED INSIDE METER BOX PRIOR TO OCCUPANCY PERMIT OR CERTIFICATE OF FINAL INSPECTION ISSUE.

N29
THESE NOTES ARE NEITHER EXHAUSTIVE NOR A SUBSTITUTE FOR REGULATIONS, STATUTORY REQUIREMENTS, BUILDING PRACTICE OR CONTRACTUAL OBLIGATIONS AND UNLESS EXPRESSLY STATED OTHERWISE, ARE PROVIDED ONLY AS GUIDELINES. NO RESPONSIBILITY IS ACCEPTED FOR THEIR USE.

N30: THESE PLANS HAVE BEEN PREPARED FOR THE EXCLUSIVE USE BY THE CLIENT OF DERBYSHIRE HOMES FOR THE PURPOSE EXPRESSED NOTIFIED TO DERBYSHIRE HOMES. ANY OTHER PERSON WHO USES OR RELIES ON THESE PLANS WITHOUT DERBYSHIRE'S WRITTEN CONSENT DOES SO AT THEIR OWN RISK AND NO RESPONSIBILITY IS ACCEPTED BY DERBYSHIRE FOR SUCH USE AND/OR RELIANCE.

THE APPROVAL BY THIS OFFICE OF A SUBSTITUTE MATERIAL, WORK PRACTICE, VARIATION OR THE LIKE IS NOT AN AUTHORISATION FOR ITS USE OR A CONTRACT VARIATION. ANY SAID VARIATIONS MUST BE ACCEPTED BY ALL PARTIES TO THE AGREEMENT AND WHERE APPLICABLE THE RELEVANT BUILDING SURVEYOR PRIOR TO IMPLEMENTING THE SAID VARIATION

SITE ENVIRONMENT DESIGN INFORMATION

SITE BUSHFIRE ATTACK ASSESSMENT

REFERENCE DOCUMENT 'AS 3959-2009 CONSTRUCTION OF BUILDINGS IN BUSH FIRE PRONE AREAS

- NOT APPLICABLE FOR THIS SITE

SEN2: SITE CLASSIFICATION

SITE CLASSIFICATION AS CLASS: 'P' REFER TO SOIL REPORT NO: 22274 DATED: 28 NOV 2016 BY: P.J. Yttrup & Associates Pty Ltd

DESIGN GUST WIND SPEED/WIND CLASSIFICATION

WIND RATING: N

BUILDING TIE DOWNS TO BE PROVIDED IN ACCORDANCE WITH AS1684 FOR AN ASSUMED DESIGN GUST WIND SPEED / WIND CLASSIFICATION OF N3. REFER TO AS1684 FOR CONSTRUCTION

REQUIREMENTS REFER TO WIND CLASSIFICATION REPORT: 191827

DATED: 28.5.19 BY: SIMON ANDERSON CONSULTANTS

SEN4:

CLIMATE ZONE

CLIMATE ZONE FOR THERMAL DESIGN / THERMAL PERFORMANCE ASSESSMENT: ZONE 6

SEN5:

CORROSION PROTECTION OF BUILT-IN STRUCTURAL MEMBERS

PROVIDE CORROSION PROTECTION OF BUILT-IN STRUCTURAL STEEL MEMBERS SUCH AS STEEL LINTELS, SHELF ANGLES, CONNECTORS, ACCESSORIES (OTHER THAN WALL TIES) IN ACCORDANCE WITH TABLE 4.1 OF AS4773.1-2015 MASONRY IN SMALL BUILDINGS, PART 1: DESIGN SUITABLE FOR AN ENVIRONMENT CLASSIFICATION SEVERE MARINE (TBC BY BUILDER)

CORROSION PROTECTION FOR SHEET ROOFING PROVIDE CORROSION PROTECTION FOR SHEET ROOFING IN ACCORDANCE WITH NCC TABLE 3.5.1.1A SUITABLE FOR AN ENVIRONMENT CLASSIFICATION HIGH (TBC BY BUILDER)

ENERGY RATING & REQUIREMENTS TBC BY ASSESSOR

BY: DALE BRADFORD - THERMORATE SOLUTIONS ACCREDITATION NO. VIC/BDAV/16/1760

PROVIDE R6.0 BULK INSULATION TO WHOLE CEILING/ROOF AREA THROUGHOUT THE RESIDENCE AND GARAGE. PROVIDE AG FOIL TO UNDERSIDE OF IRON ON THE WHOLE ROOF AREA.

PROVIDE R2.5 BULK INSULATION TO ALL BY EXTERNAL WALLS WITH 40MM AIR GAP PLUS AG FOIL WRAP PROVIDE R2.5 BULK INSULATION TO ALL EXTERNAL STUD WALLS WITH PERMEABLE VAPOUR WRAP BEHIND THE METAL

PROVIDE R2.5 BUILK INSUI ATION TO ALL EXTERNAL STUD WALLS WITH PERMEABLE VAPOUR WRAP BEHIND THE EPS. 100MM RENDERED CLADDING.

PROVIDE R2.0 BULK INSULATION TO THE FRAMED TIMBER FLOOR ON THE UPPER LEVEL THAT CONNECTS TO THE CEILING ON THE LOWER LEVEL ROOMS. PROVIDE R4.0 BULK INSULATION TO THE FRAMED TIMBER FLOOR ON THE UPPER LEVEL THAT IS CANTER LEVERED OUT

FROM THE LOWER FLOOR LEVEL. PROVIDE R2.5 BULK INSULATION TO ALL INTERNAL WALLS BETWEEN UN-CONDITIONED AND CONDITIONED AREA'S

SUCH AS THE GARAGE, LAUNDRY, POWDER, BATH.
PROVIDE R2.5 BULK INSULATION TO ALL INTERNAL WALLS THAT CONNECT TO CEILING/ROOF VOID SPACES WHERE CEILING HEIGHTS CHANGE.

PROVIDE RI.79 EPS FOAMULAR 50MM OR EQUIVALENT UNDER THE CONCRETE SLAB ON THE LOWER LEVEL. (EXCLUDING THE GARAGE, STORE & WET FLOOR AREA'S)

CSOG FLOOR GROUND LEVEL AND TIMBER FLOOR FRAMED CONSTRUCTION TO UPPER LEVEL ON THIS PROJECT. PROJECT RATED WITH RECESSED LED DOWNLIGHTS AS SHOWN ON ENDORSED PLANS. ALUMINIUM FRAME TREND DOUBLE GLAZED CLEAR AWNING WINDOWS/DG (U=4.50, SHGC=0.51) ALL AWNING

WINDOWS ALUMINIUM FRAME ANEETA DOUBLE GLAZED CLEAR DOUBLE HUNG WINDOWS/DG (U=4.23, SHGC=0.60) ALL DOUBLE

HUNG WINDOWS
ALUMINIUM FRAME TREND DOUBLE GLAZED CLEAR FIXED WINDOWS/DG (U=3.29, SHGC=0.65) ALL FIXED WINDOWS ALUMINIUM FRAME TREND DOUBLE GLAZED CLEAR HINGED DOOR/DG (U=3.71, SHGC=0.61) ALL HINGED DOORS ALUMINIUM FRAME TREND DOUBLE GLAZED CLEAR SLIDING DOORS/DG (U=3.71, SHGC=0.62) ALL SLIDING DOORS DARK COLOUR ROOF IRON MODELLED TO THIS PROJECT AS NOMINATED.

ALL DOORS TO BE WEATHER STRIPPED BETWEEN DOORS/FRAME AND DRAFT EXCLUDER FITTED AT BASE OF DOOR TO CREATE SEAL WHEN CLOSED.

ALL OPENABLE WINDOWS TO HAVE WEATHERSTRIP BETWEEN FRAME AND SASH TO CREATE SEAL WHEN CLOSED. ALL GENERAL BUILDING GAPS AND CRACKS TO BE SEALED.

ALL WINDOWS MODELLED WITH FLYSCREENS.

EXHAUST FANS: KITCHEN TO HAVE ONE SEALED EXHAUST FAN ABOVE/WITHIN RANGE HOOD.
ALL EXHAUST FANS SHOULD BE SELF-SEALING WHEN NOT IN USE TO PROVIDE SEAL AGAINST UNWANTED VENTILATION. THIS RATING ONLY APPLIES TO THE FLOOR PLAN, CONSTRUCTION DETAILS, ORIENTATION AND CLIMATE

AS SUBMITTED AND INCLUDED IN THE ATTACHED STAMPED PLANS.
AS PART OF SIX STAR ENERGY RATING REQUIREMENTS , THE OWNERS SHALL PROVIDE A MIN 2000LITRE WATERTANK TO FLUSH ALL WC'S IN DWELLING OR
ALTERNATIVELY PROVIDE A SOLAR H.W.S. WHERE SITE IS IN A PURPLE PIPE ESTATE, (RECLAIMED WATER ON A SEPARATE

TAP SYSTEM FOR FLUSHING

WCS AND LISE FOR GARDEN NO SOLAR OR RAINWATER TANK IS REQUIRED. SPECIAL NOTE: UNDER THE NCC 3.12.1.5 (C)(I) WITH IN-SLAB OR IN-SCREED HEATING OR COOLING SYSTEM YOU MUST

HAVE INSULATION WITH AN R-VALUE OF NOT LESS THAN R1.0 INSTALLED AROUND THE VERTICAL EDGE OF ITS PERIMETER. THIS DOES NOT APPLY IF IT'S ONLY A BATHROOM OR AMENITY AREA'S OR THE LIKE.

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NOTES

Notify Derbyshire Homes of any discrepancies. Drawings to be read

ORIGINAL A3

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J	11.11.19	FLOOR SET DOWN	ALT	AR

CLIENT

BRENDAN PETER BORG

PROJECT

LOT 09 (No. 15) CALIMO PLACE INDENTED HEAD 3223

GENERAL NOTES

Derbyshire

DRAWN	CHECKED	SCALE
ALT	AR	N/A
DATE	PROJECT No	STATUS
1.11.2019	G1811	CD
DRAWING No		REV
A01		

DEVELOPMENT DATA

PROPOSED DATA - NEW RESIDENCE

575,701 M2 61.96 SQ

BUILDING SITE COVERAGE (AREA M2) GROUND FLOOR

143,165 M2 15.41 SQ HOUSE: 109,246 M2 11.76 SQ 41,145 M2 4.42 SQ 3,967 M2 0.43 SQ GARAGE: ALFRESCO: ENTRY DECK: DRIVEWAY: 26.163 M2 2.82 SQ

TOTAL BUILDING AREA: 323,656M2 34.83 SQ

NOTES

THE LOCATION OF SERVICES IS APPROXIMATE ONLY.
BUILDER TO DETERMINE THE EXACT LOCATION OF SERVICES
ON SITE PRIOR TO DEMOLITION

ALL EXISTING SITE LEVELS SHOWN ON THESE DRAWINGS ARE BASED ON SURVEY PLAN PREPARED BY TGM GROUP DWG REF NO. 15084-01-FS01 REV. 1-. DATE OF ISSUE 01.03.2016. BUILDER TO CONFIRM ALL LEVELS ON SITE.

REFER TO ROOF PLAN FOR DETAILS OF ROOFING AND

ROOF PLUMBING

REFER TO STRUCTURAL ENGINEERS DRAWINGS FOR DETAILS

BUILDER TO ALLOW FOR ALL NECESSARY EXCAVATION, BACKFILLING AND OTHER EARTH MOVING TO RE-ESTABLISH EXISTING GROUND LEVELS EXCEPT WHERE NOTED

LOCATION OF TITLE BOUNDARY IS BASED ON ASSUMPTION THAT EXISTING FENCES REPRESENT TRUE BOUNDARY. A RE-ESTABLISHMENT SURVEY MAY BE REQUIRED.

MATERIALS & FINISHES SCHEDULE

CARPET

COLORBOND

CB PB RF PLASTERBOARD PAINT FINISH

RENDERED FOAM


REFER TO DERBYSHIRE SPECIFICATION FOR COMPLETE SPECIFICATION OF MATERIALS & DETAILS OF FINISH.

ABBREVIATIONS

DOWNPIPE DP FFL FINISH FLOOR LEVEL RELATIVE LEVEL RAINWATER TANK ELECTRICAL METERBOARD WATER MAIN INSTANTANEOUS HOT WATER IHW SWINGIN GATE

EQUINOX SHADOW



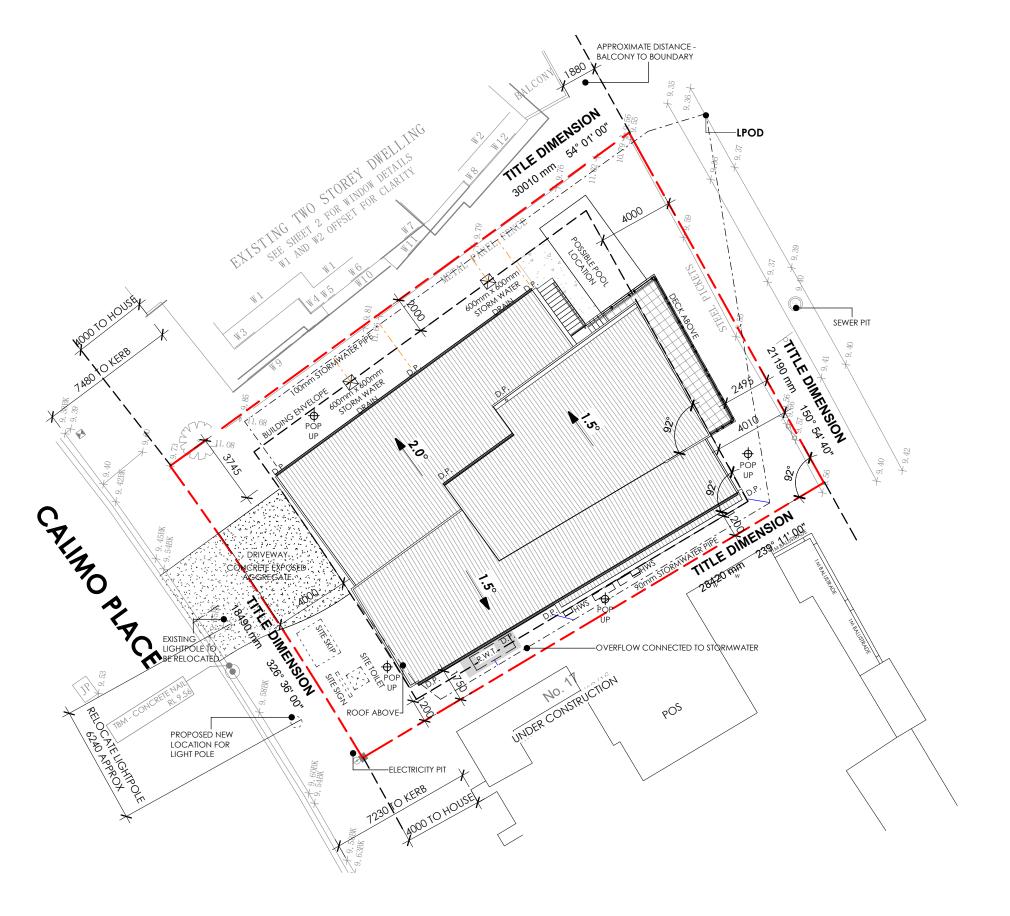

NOTES ORIGINAL A3

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BRENDAN PETER BORG

PROJECT

LOT 09 (No. 15) CALIMO PLACE INDENTED HEAD 3223

DRAWING

SITE PLAN

Derbyshire

DRAWN	CHECKED	SCALE
ALT	AR	1:200
DATE	PROJECT No	STATUS
1.11.2019	G1811	CD
DRAWING No		REV
A02		

NOTES ALL DIMENSIONS TO BE CHECKED AND VERIFIED ON SITE. DO NOT SCALE FROM DRAWINGS CONTRACTOR TO OBTAIN DERBYSHIRE'S PRIOR WRITTEN APPROVAL FOR ANY EXTRA WORK OR ALTERATIONS TO APPROVED DRAWINGS 8815 SETBACK TITLE DIMENSION A FULL SET OF LAMINATED DRAWINGS AND SPECIFICATIONS TO BE KEPT ON SITE IN GOOD CONDITION AT ALL TIMES 17345 O/ALL N4: SHOULD DISCREPANCIES OR ERROR BE 17045 DISCOVERED ON THE DRAWINGS OR SPECIFICATIONS, DERBYSHIRE MUST BE NOTIFIED IMMEDIATELY 3855 SETBACK 2000 N5: ALL BUILDING WORKS TO BE COMPLETED IN 1370 3640 ACCORDANCE WITH THE NCC/BCA AND TO THE SATISFACTION OF THE LOCAL AUTHORITY AND OR 4450 BUILDING SURVEYOR N6: REFER TO DOOR & WINDOW SCHEDULES FOR COMPLETE DIMENSIONS & DETAILS SETBACK WATERPROOFING OF WET AREAS, BEING BATHROOMS, SHOWERS, SHOWER ROOMS, LAUNDRIES, SANITARY COMPARTMENTS AND THE LIKE SHALL BE PROVIDED IN ACCORDANCE WITH AS3740-2010: WATERPROOFING OF DOMESTIC 3490 CONCRETE SLAB ON GROUND RL: 9.810m 4480 3480 SLAB TO ENGINEERS DESIGN & SLAB TO ENGINEERS CONCRETE SLAB DESIGN & SPECIFICATIONS ON GROUND RL: 9.810m 1530 7830 O/ALL 7380 4450 ON GROUND RL: 9.810m CONCRETE PAVING SLAB CONCRETE SLAB 4865 90mm STEP RL:9.900m SET DOWN 50mm RL: 9.850m EXPOSED AGGREGATE LIFT PIT DEPTH -ZERO THRESHOLD DRAIN RECESSED 180mm RL: 9.720m 2710 1550 3010 1600 ALLOW TWO 100mm ELECTRICAL CONDUITS CONCRETE SLAB ON GROUND REFER TO LIFT SPECIFICATIONS FOR DETAILS. 1790 SLAB TO ENGINEERS TITLE DIMENSION 18490 mm 326° 36' 00" **TITLE DIMENSION** 21190 mm 150° 54' 40" **SPECIFICATIONS** 2100 2265 R.W.T. SLAB CONCRETE SLAB 200 SET DOWN 50mm **TITLE DIMENSION** RL: 9.850m 14575 2540 2665

8380

4505

SETBACK

19780

20000 O/ALL

11600

NOTES ORIGINAL A3

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LOT 09 (No. 15) CALIMO PLACE INDENTED HEAD 3223

DRAWING


3915

SETBACK

SETOUT PLAN

Derbyshire

DRAWN	CHECKED	SCALE
ALT	AR	1:100
DATE	PROJECT No	STATUS
1.11.2019	G1811	CD
DRAWING No		REV
A03		

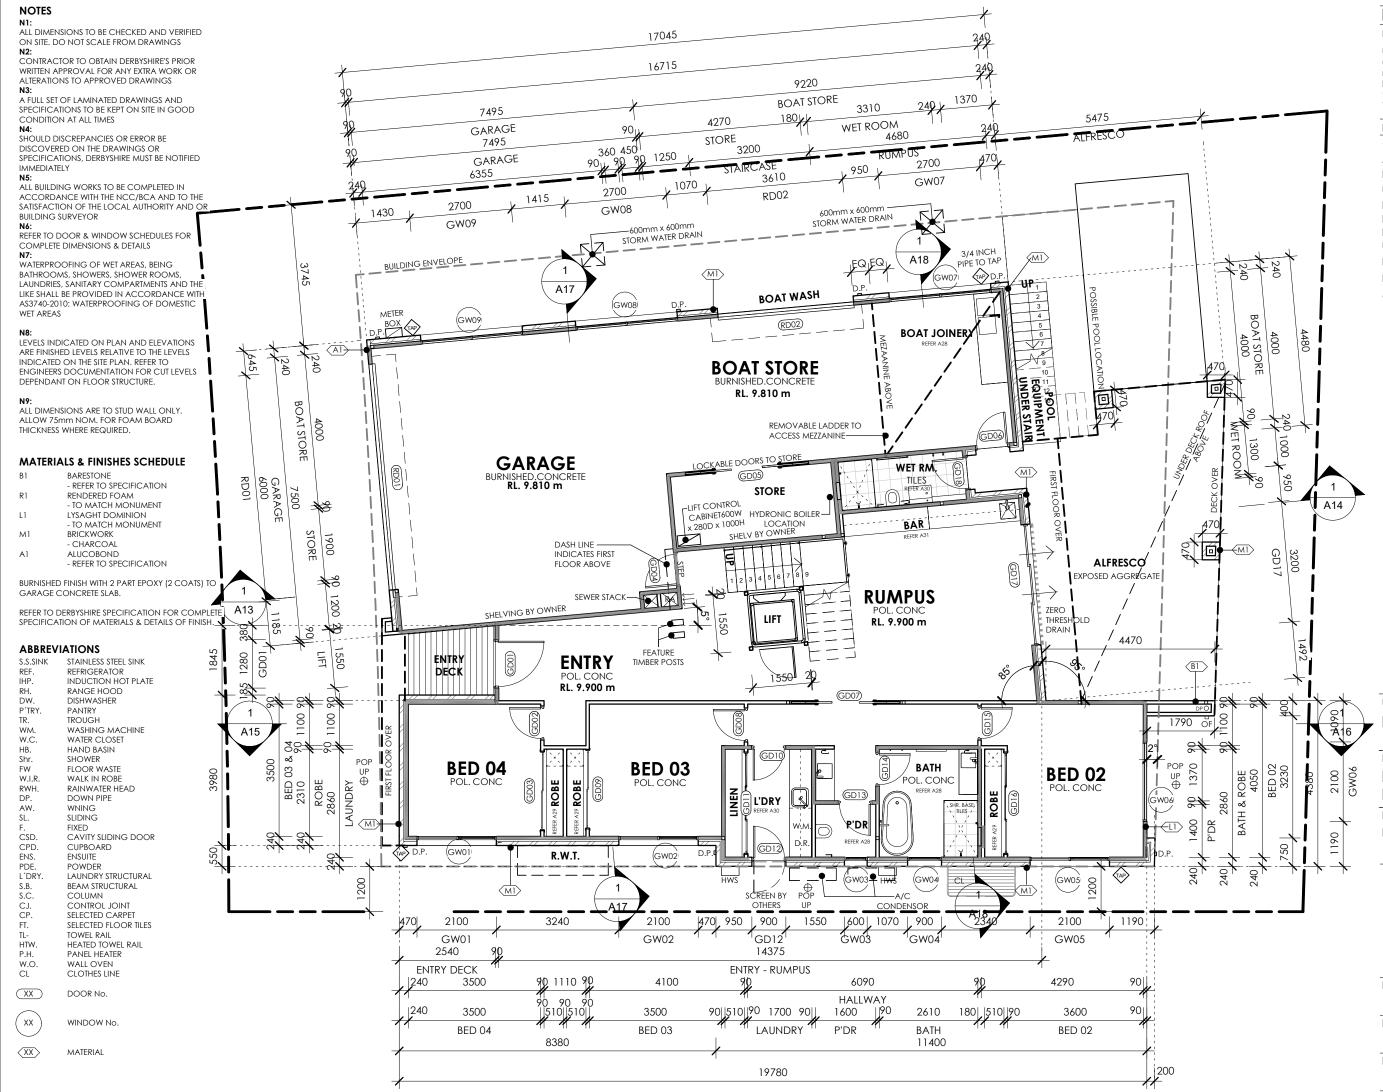

NOTES ORIGINAL A3

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/	DATE	DESCRIPTION	DRN	CHKD
	14.05.19	CONSTRUCTION ISSUE	ALT	AR
	05.07.19	LIFT COORDINATION	ALT	AR
	09.07.19	NGL COORDINATION	ALT	AR
	23.08.19	HEIGHT + WINDOWS	ALT	AR
	02.09.19	17 CALIMO PL	ALT	AR
	05.09.19	WINDOWS	ALT	AR
	12.09.19	NEIGHBOURS CONSENT	ALT	AR
	19.09.19	LIFT RELOCATED	ALT	AR
	08.10.19	LIGHT POLE	ALT	AR
	01.11.19	BUILDING ENVELOPE	ALT	AR
	11.11.19	FLOOR SET DOWN	ALT	AR

CLIENT

BRENDAN PETER BORG

PROJECT

LOT 09 (No. 15) CALIMO PLACE INDENTED HEAD 3223

RAWING

GROUND LEVEL FLOOR PLAN

Derbyshire

DRAWN	CHECKED	SCALE
ALT	AR	1:100
DATE	PROJECT No	STATUS
1.11.2019	G1811	CD
DRAWING No		REV
A04		

NCC 2019 BCA VOL 2 ALL MATERIALS AND WORK PRACTICES SHALL COMPLY WITH, BUT NOT LIMITED TO THE BUILDING REGULATIONS 2006, NATIONAL CONSTRUCTION CODE SERIES 2019 BUILDING CODE OF AUSTRALIA VOL 2 AND ALL RELEVANT CURRENT AUSTRALIAN STANDARDS (AS AMENDED) REFERRED TO THEREIN. UNLESS OTHERWISE SPECIFIED, THE TERM NCC SHALL REFER TO NATIONAL CONSTRUCTION CODE SERIES 2019 BUILDING CODE OF AUSTRALIA

ALL MATERIALS AND CONSTRUCTION PRACTICE SHALL MEET THE PERFORMANCE REQUIREMENTS OF THE BCA. WHERE AN ALTERNATIVE SOLUTION IS PROPOSED THEN, PRIOR TO IMPLEMENTATION OR INSTALLATION, IT FIRST MUST BE ASSESSED AND APPROVED BY THE RELEVANT BUILDING SURVEYOR AS MEETING THE PERFORMANCE REQUIREMENTS OF THE NCC.

GLAZING, INCLUDING SAFETY GLAZING, SHALL BE INSTALLED TO A SIZE, TYPE AND THICKNESS SO AS TO COMPLY WITH:- BCA PART 3 FOR CLASS 1 AND 10 BUILDINGS WITHIN A DESIGN WIND SPEED OF NOT MORE THAN N3; AND - NCC 2014 BCA VOL 1 PART B1.4 FOR CLASS 2 AND 9 BUILDINGS.

THESE DRAWINGS SHALL BE READ IN CONJUNCTION WITH ANY HOUSE ENERGY RATING
(HERS) REPORT AND SHALL BE CONSTRUCTED IN ACCORDANCE WITH THE STAMPED PLANS ENDORSED BY THE ACCREDITED THERMAL PERFORMANCE ASSESSOR WITHOUT ALTERATION

WHERE REQUIRED TREAT AREA BENEATH FLOOR AGAINST TERMITE INFESTATION IN ACCORDANCE WITH RELEVANT STANDARD, CONTACT THE RELEVANT MUNICIPAL COUNCIL TO DETERMINE IF THIS IS MANDATORY

REFER SCHEDULES FOR DIMENSIONED DOOR &

WINDOW FLEVATIONS, WINDOW SIZES NOMINATED ARE NOMINAL ONLY, ACTUAL SIZES MAY VARY ACCORDING TO MANUFACTURER

STEPS TO DECK AS REQUIRED. 190MM MAX. RISER. 250MM MIN. GOING TREADS

MATERIALS & FINISHES SCHEDULE

BARESTONE - REFER TO SPECIFICATION RENDERED FOAM
- TO MATCH MONUMENT LYSAGHT DOMINION - TO MATCH MONUMENT BRICKWORK - CHARCOAL ALUCOBOND

- REFER TO SPECIFICATION FRAMES POWDERCOATED - TO MATCH MONUMENT COLORBOND FASCIA -MONUMENT

COLORBOND GUTTER - MONUMENT

REFER TO DERBYSHIRE SPECIFICATION FOR COMPLETE SPECIFICATION OF MATERIALS & DETAILS OF FINISH.

ABBREVIATIONS


BARGE FLASHING & CAPPING STEEL COLUMN DOWNPIPE EXH EXHAUST DUCT FCL FFL FINISHED CEILING LEVEL FINISHED FLOOR LEVEL G GAS SWINGING GATE EXTERNAL GAS OUTLET INSTANTANEOUS HOT WATER MB NGL ELECTRICAL METERBOARD NATURAL GROUND LINE OP PC RL OVERFLOW POP PARAPET CAPPING RELATIVE LEVEL RWT RWH RAINWATER TANK RAINWATER HEAD


SPREADER

XXDOOR No

XX WINDOW No.



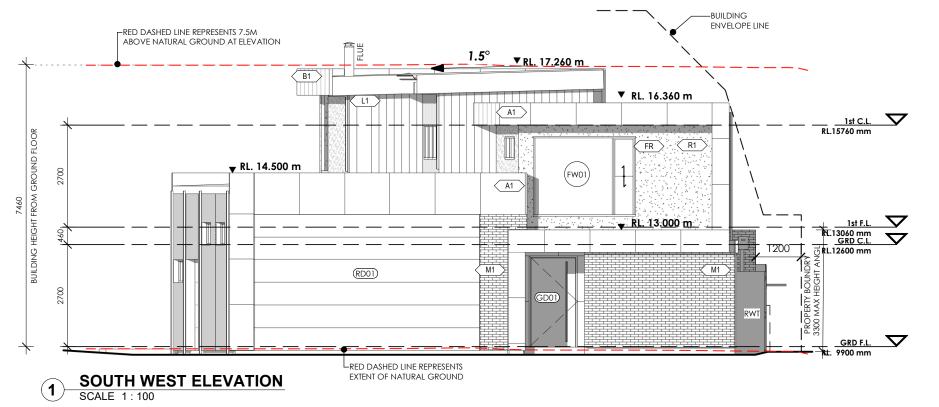

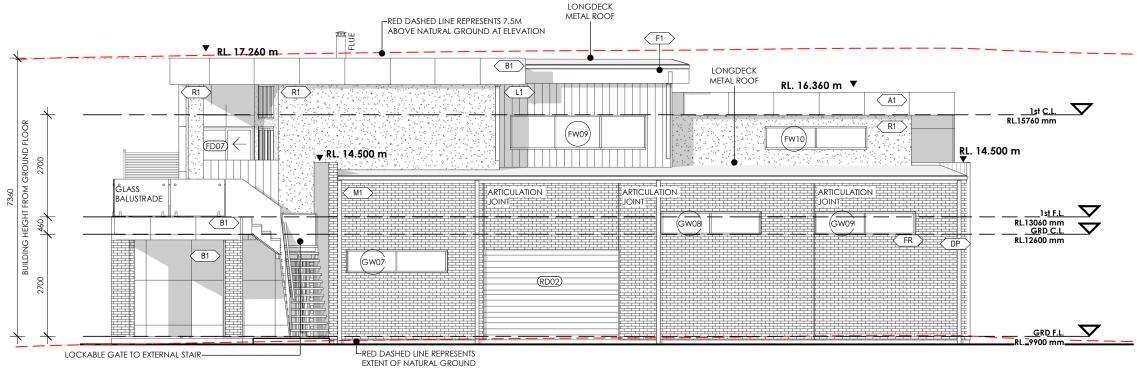

NORTH WEST ELEVATION SCALE 1:100

NOTES ORIGINAL A3

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G	19.09.19	LIFT RELOCATED	ALT	AR
Н	08.10.19	LIGHT POLE	ALT	AR
	01.11.19	BUILDING ENVELOPE	ALT	AR
J	11.11.19	FLOOR SET DOWN	ALT	AR

CLIENT

BRENDAN PETER BORG

PROJECT

LOT 09 (No. 15) CALIMO PLACE INDENTED HEAD 3223

DRAWING

ELEVATIONS

Derbyshire

DRAWN	CHECKED	SCALE
ALT	AR	1:100
DATE	PROJECT No	STATUS
1.11.2019	G1811	CD
DRAWING No		REV
A06		

NCC 2019 BCA VOL 2 ALL MATERIALS AND WORK PRACTICES SHALL COMPLY WITH, BUT NOT LIMITED TO THE BUILDING REGULATIONS 2006, NATIONAL CONSTRUCTION CODE SERIES 2019 BUILDING CODE OF AUSTRALIA VOL 2 AND ALL RELEVANT CURRENT AUSTRALIAN STANDARDS (AS AMENDED) REFERRED TO THEREIN. UNLESS OTHERWISE SPECIFIED, THE TERM NCC SHALL REFER TO NATIONAL CONSTRUCTION CODE SERIES 2019 BUILDING CODE OF AUSTRALIA

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N4: WHERE REQUIRED TREAT AREA BENEATH FLOOR AGAINST TERMITE INFESTATION IN ACCORDANCE WITH RELEVANT STANDARD, CONTACT THE RELEVANT MUNICIPAL COUNCIL TO DETERMINE IF THIS IS MANDATORY

REFER SCHEDULES FOR DIMENSIONED DOOR & WINDOW ELEVATIONS. WINDOW SIZES NOMINATED ARE NOMINAL ONLY, ACTUAL SIZES MAY VARY ACCORDING TO MANUFACTURER

STEPS TO DECK AS REQUIRED. 190MM MAX. RISER. 250MM MIN. GOING TREADS

MATERIALS & FINISHES SCHEDULE

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- TO MATCH MONUMENT LYSAGHT DOMINION - TO MATCH MONUMENT BRICKWORK - CHARCOAL ALUCOBOND - REFER TO SPECIFICATION FRAMES POWDERCOATED - TO MATCH MONUMENT

COLORBOND FASCIA -MONUMENT COLORBOND GUTTER

- MONUMENT

REFER TO DERBYSHIRE SPECIFICATION FOR COMPLETE SPECIFICATION OF MATERIALS & DETAILS OF FINISH.

ABBREVIATIONS


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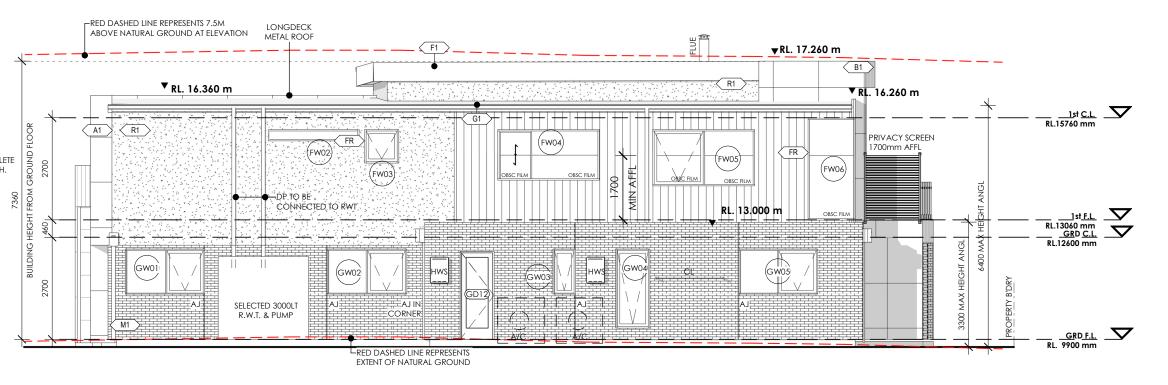
(XX)DOOR No.

SPREADER

XX WINDOW No.

 $\langle XX \rangle$ MATERIAL



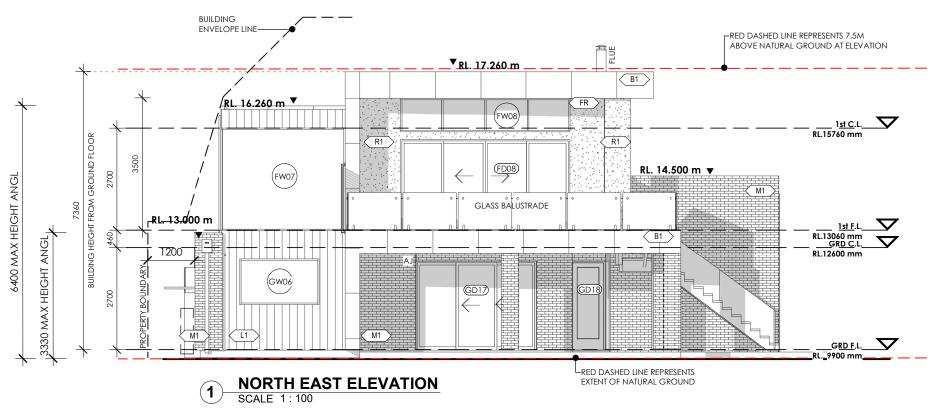

SOUTH EAST ELEVATION

NOTES ORIGINAL A3

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G	19.09.19	LIFT RELOCATED	ALT	AR
Н	08.10.19	LIGHT POLE	ALT	AR
	01.11.19	BUILDING ENVELOPE	ALT	AR
J	11.11.19	FLOOR SET DOWN	ALT	AR

CLIENT

BRENDAN PETER BORG

PROJECT

LOT 09 (No. 15) CALIMO PLACE INDENTED HEAD 3223

DRAWING

ELEVATIONS

Derbyshire

DRAWN	CHECKED	SCALE
ALT	AR	1:100
DATE	PROJECT No	STATUS
1.11.2019	G1811	CD
DRAWING No		REV
A07		

ALL CEILING AREAS TO BE SQUARE SET UNLESS NOTED

OTHERWISE

ALL BULKHEADS TO BE SQUARE SET TO CEILING PLANES

ALL CEILING HEIGHTS AS NOMINATED ON PLANS

REFER TO ELECTRICAL PLANS FOR LIGHTING INFORMATION

MATERIALS & FINISHES SCHEDULE

REFER TO DERBYSHIRE SPECIFICATION FOR COMPLETE SPECIFICATION OF MATERIALS & DETAILS OF FINISH.


ABBREVIATIONS

BULKEADH

CEILING HEIGHT FROM FINISH FLOOR LEVEL

EXHAUST DUCT AS SPEC. FINISHED CEILING LEVEL EXH FCL

RELATIVE LEVEL

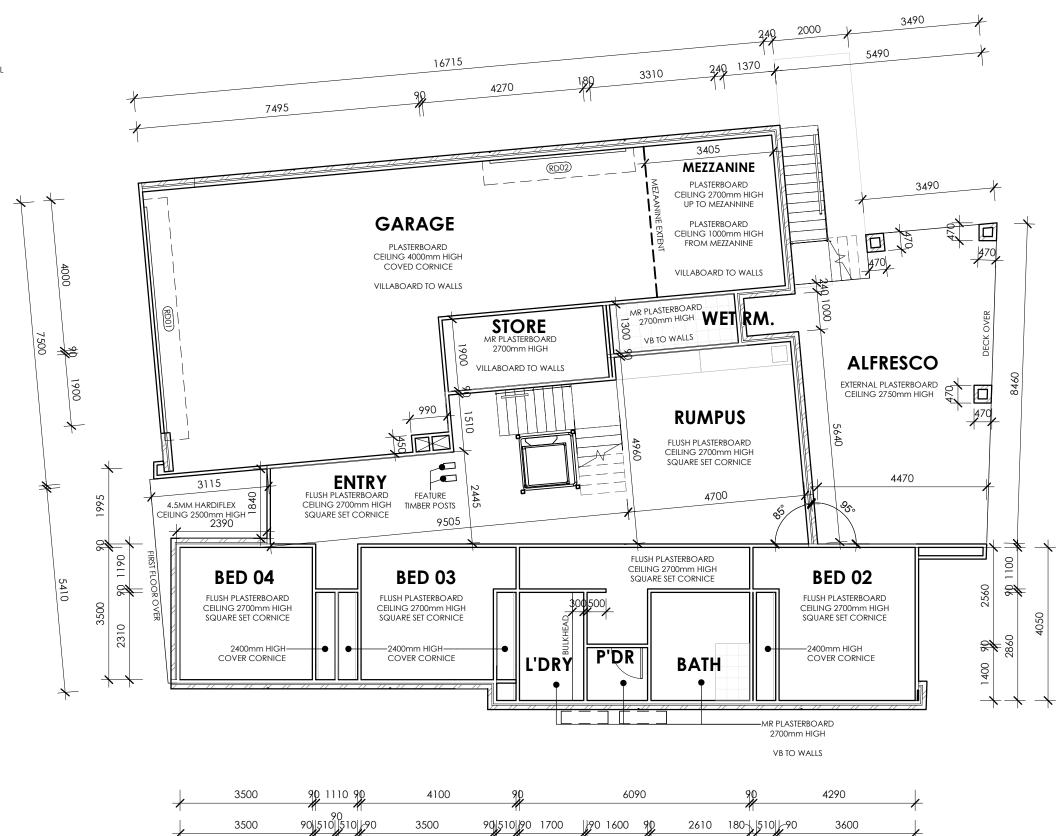

NOTES ORIGINAL A3

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	J 1	1 11 3	,	
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Н	08.10.19	LIGHT POLE	ALT	AR
	01.11.19	BUILDING ENVELOPE	ALT	AR
J	11.11.19	FLOOR SET DOWN	ALT	AR

CLIENT

BRENDAN PETER BORG

PROJECT

LOT 09 (No. 15) CALIMO PLACE INDENTED HEAD 3223

GROUND FLOOR REFLECTED CEILING

Derbyshire

DRAWN	CHECKED	SCALE
ALT	AR	1:100
DATE	PROJECT No	STATUS
1.11.2019	G1811	CD
DRAWING No		REV
80A		

ALL CEILING AREAS TO BE SQUARE SET UNLESS NOTED OTHERWISE

ALL BULKHEADS TO BE SQUARE SET TO CEILING PLANES

ALL CEILING HEIGHTS AS NOMINATED ON PLANS

REFER TO ELECTRICAL PLANS FOR LIGHTING INFORMATION

MATERIALS & FINISHES SCHEDULE

REFER TO DERBYSHIRE SPECIFICATION FOR COMPLETE SPECIFICATION OF MATERIALS & DETAILS OF FINISH.


ABBREVIATIONS

BULKEADH

CEILING HEIGHT FROM FINISH FLOOR LEVEL

CH EXH FCL EXHAUST DUCT AS SPEC. FINISHED CEILING LEVEL

RELATIVE LEVEL

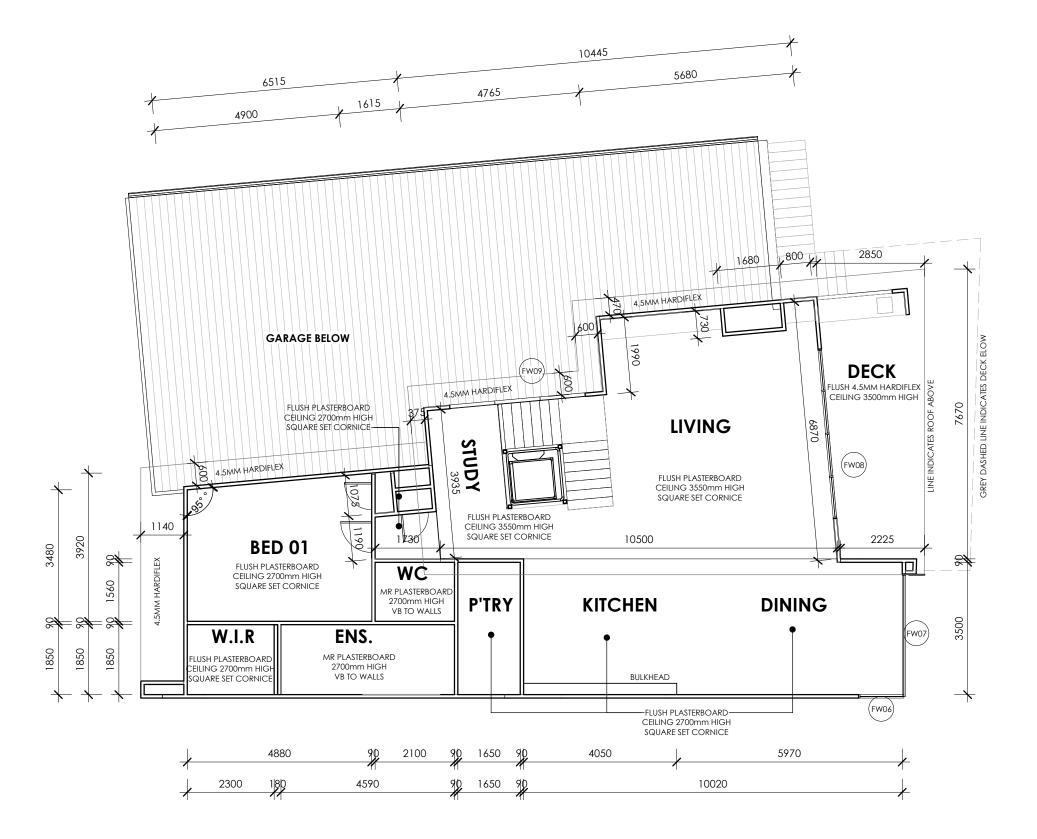

NOTES ORIGINAL A3

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J	11.11.19	FLOOR SET DOWN	ALT	AR

CLIENT

BRENDAN PETER BORG

PROJECT

LOT 09 (No. 15) CALIMO PLACE INDENTED HEAD 3223



FIRST FLOOR REFLECTED CEILING PLAN

Derbyshire

DRAWN	CHECKED	SCALE
ALT	AR	1:100
DATE	PROJECT No	STATUS
1.11.2019	G1811	CD
DRAWING No		REV
A09		

N1: RESIDENCE - 3.5 W/M2

GARAGE - 1.6 W/M2

PROVIDE POWER FOR: - KITCHEN

- DISHWASHER

- OVFN

- RANGEHOOD - REFRIGERATOR - COOKTOP

ALL LIGHT FITTINGS & LAMPS SHOWN ARE ENERGY EFFICIENT. ANY CHANGE TO NUMBER OF OR LAMP ENERGY OUTPUT MUST BE RE-EVALUATED FOR OVERALL COMPLIANCE OF NCC/BCA PART 3.12.5.4.

ALL INTERNAL LIGHTS ARE SURFACE MOUNTED UNLESS OTHERWISE NOTED. NOTE: THE R VALUE OF THE CEILING INSULATION MUST BE INCREASED WHERE CEILING INSULATION IS REMOVED AROUND DOWN LIGHTS AND EXHAUST FANS AS PER THE BCA TABLE 3.12.1.1A.

ALL FOR INDUSTRY APPROVED DOWNLIGHT COVERS FOR INSULATION PROTECTION AND DRAFT SEALING (EXAMPLE: IGLOO RECESSED DOWNLIGHT COVER)

ALL EXTERNAL LIGHT FITTINGS ARE TO BE MARINE GRADE AND BE CONTROLLED BY DAYLIGHT MOTION SENSORS.


REFER TO LARGE SCALE JOINERY DRAWINGS FOR SPECIFIC SWITCH & GPO LOCATIONS

SMOKE ALARMS TO BE PROVIDED AND INSTALLED IN ACCORDANCE WITH AS3786. NEW DWELLINGS AND ADDITIONS WITH SLEEPING ACCOMMODATION TO BE HARD WIRED WITH BATTERY BACK UP.

ABBREVIATIONS

RAIN WATER TANK HOT WATER SYSTEM AIR CONDITIONING HWS A/C WIRING UNDER MEZZANINE UM ABOVE MEZZANINE

2D	CAL LEGEND ITEM	No.
	METER BOX	1
Ψ	STAIR LIGHT FITTING	2
O LED.	SELECTED LED LIGHT POINT	20
DIFF.	SELECTED DIFFUSE LED LIGHT	2
FAN	SELECTED FAN/LIGHT COMBINATION	2
XT. D _{LED.}	SELECTED LED LIGHT - EXTERNAL	4
→ WALL.	SLECTED WALL LIGHT POINT	1
	TWIN LED LIGHT FITTING	13
	DOUBLE FLOOD LIGHT WITH SENSOR	6
\$	SINGLE GPO.	3
\bigotimes	DOUBLE GPO.	29
\bowtie	DOUBLE WEATHERPROOF GPO.	4
O _{S/ALARM.}	HARD WIRED SMOKE ALARM	2
lacktriangle	EXAHUST FAN DUCTED TO EXT.	2
\(\rightarrow	TV POINT	1
DATA	DATA POINT	1
× _{1/2/3}	SWITCH LOCATION	15
VO	DUCTED VACCUM- POINT	3
VM	DUCTED VACCUM - MOTOR	1
	CEILING FAN	1

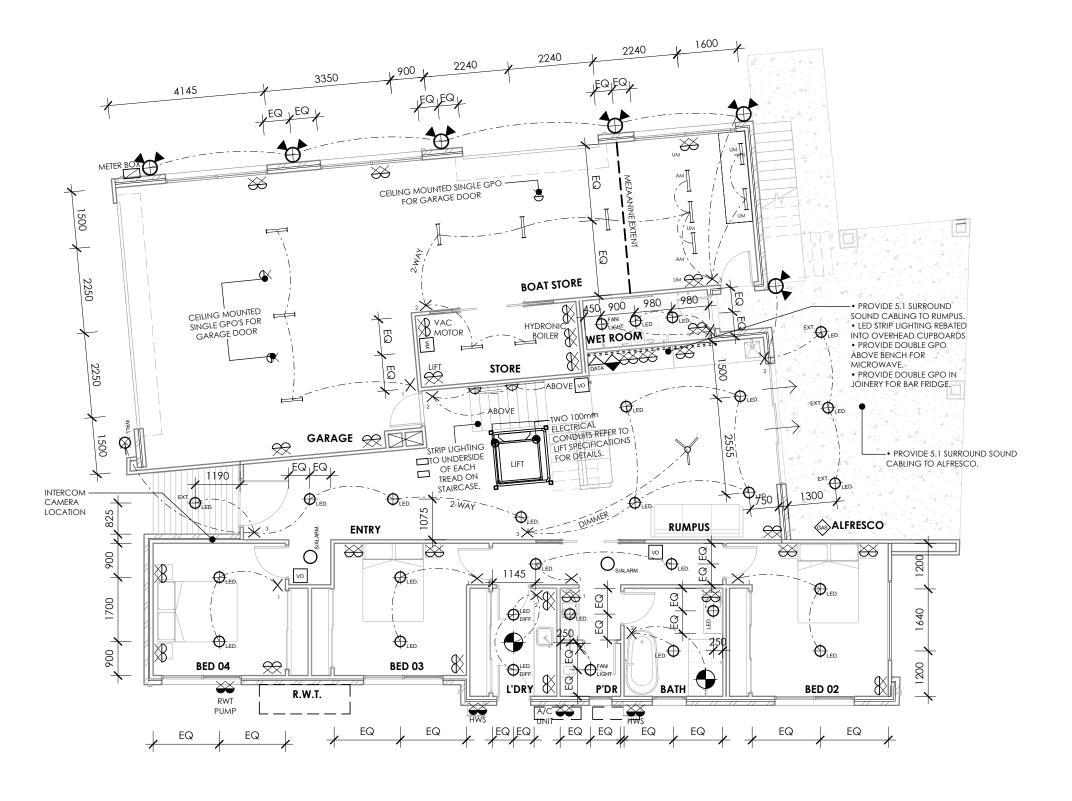

NOTES ORIGINAL A3

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)	02.09.19	17 CALIMO PL	ALT	AR
	05.09.19	WINDOWS	ALT	AR
	12.09.19	NEIGHBOURS CONSENT	ALT	AR
3	19.09.19	LIFT RELOCATED	ALT	AR
1	08.10.19	LIGHT POLE	ALT	AR
	01.11.19	BUILDING ENVELOPE	ALT	AR
]	11.11.19	FLOOR SET DOWN	ALT	AR

CLIENT

BRENDAN PETER BORG

PROJECT

LOT 09 (No. 15) CALIMO PLACE INDENTED HEAD 3223

DRAWING

A10

GROUND FLOOR ELECTRICAL PLAN

Derbyshire

Address: 98 Pakington St, Geelong West VIC 3218 Phone: (03) 5221 8409

DRAWN CHECKED SCALE ALT AR 1:100 DATE STATUS PROJECT No 1.11.2019 G1811 CD DRAWING No

REV

RESIDENCE - 3.5 W/M2

GARAGE - 1.6 W/M2

PROVIDE POWER FOR:

- KITCHEN

- DISHWASHER - OVFN

- RANGEHOOD

- REFRIGERATOR - COOKTOP

ALL LIGHT FITTINGS & LAMPS SHOWN ARE ENERGY EFFICIENT. ANY CHANGE TO NUMBER OF OR LAMP ENERGY OUTPUT MUST BE RE-EVALUATED FOR OVERALL COMPLIANCE OF NCC/BCA PART 3.12.5.4.

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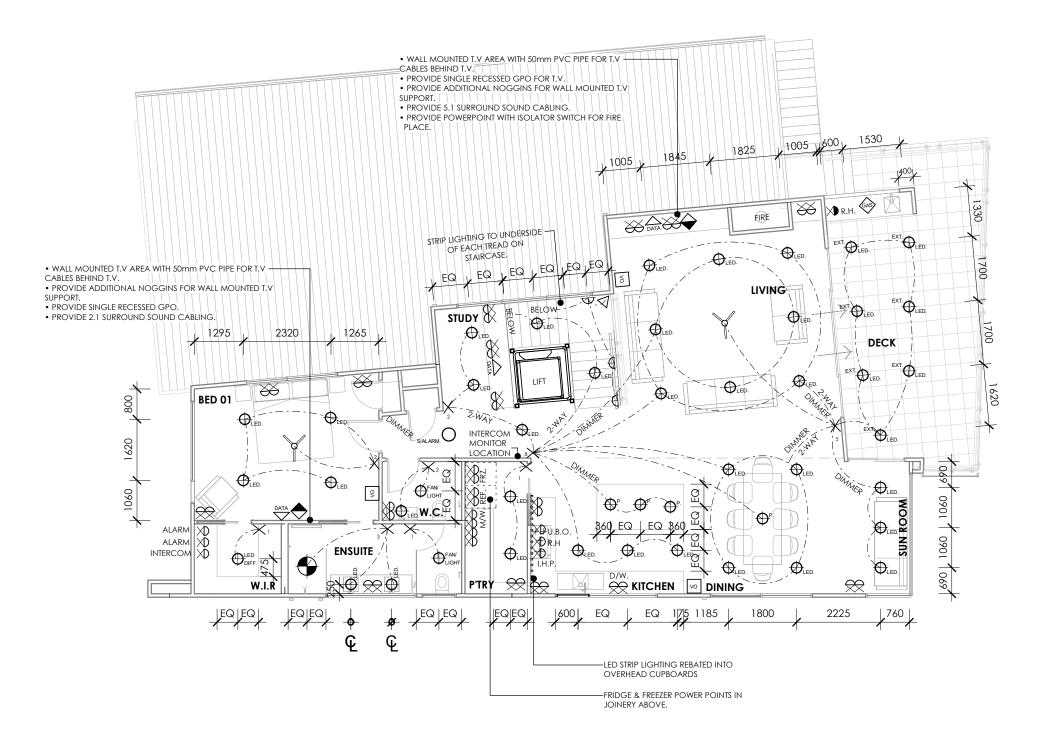
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SMOKE ALARMS TO BE PROVIDED AND INSTALLED IN ACCORDANCE WITH AS3786. NEW DWELLINGS AND ADDITIONS WITH SLEEPING ACCOMMODATION TO BE HARD WIRED WITH BATTERY BACK UP.

ABBREVIATIONS

MICROWAVE REF FRZ RFFRIGFRATOR FREEZER RANGEHOOD HOT PLATE UNDER BENCH OVEN D/W DISHWASHER WIRING

	ELECTRIC 2D	CAL LEGEND ITEM	N
	Ψ	STAIR LIGHT FITTING	3
	⊕ LED.	SELECTED LED LIGHT POINT	32
	FAN	SELECTED FAN/LIGHT COMBINATION	2
E)	LED.	SELECTED LED LIGHT - EXTERNAL	7
	\triangleleft	LIGTH SENSOR POINT	1
	\rightleftharpoons	SINGLE GPO.	6
	\approx	DOUBLE GPO.	20
	\$	SINGLE WEATHERPROOF GPO.	1
	$O_{S/ALARM.}$	HARD WIRED SMOKE ALARM	1
	•	EXAHUST FAN DUCTED TO EXT.	1
	\(\rightarrow	TV POINT	2
	DATA	DATA POINT	3
	× _{1/2/5/8}	SWITCH LOCATION	9
	VO	DUCTED VACCUM- POINT	3
	Y	CEILING FAN	2



NOTES ORIGINAL A3

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J	11.11.19	FLOOR SET DOWN	ALT	AR

CLIENT

BRENDAN PETER BORG

PROJECT

LOT 09 (No. 15) CALIMO PLACE INDENTED HEAD 3223

DRAWING

FIRST FLOOR ELECTRICAL PLAN

Derbyshire

DRAWN	CHECKED	SCALE
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1.11.2019	G1811	CD
DRAWING No		REV
A11		

THE LOCATION OF ALL ROOF EQUIPMENT TO BE VERIFIED ON SITE PRIOR TO INSTALLATION

NZ:
CONNECT DOWNPIPES TO RAINWATER TANK.
STORMWATER OVERFLOW TO BE TAKEN TO THE
LEGAL POINT OF DISCHARGE TO THE RELEVANT
AUTHORITIES APPROVAL.

INSTALL ALL FLASHINGS AND CAPPING'S AS NECESSARY TO ENSURE COMPLETE ROOF WATER

REFER TO ENGINEERS DOCUMENTATION FOR COMPLETE STORMWATER DESIGN

DEKTITE FLASHING TO ROOF PENETRATIONS

BOX GUTTER SIZE 400MM X 100MM DEEP MINIMUM. ENGINEER TO CHECK & CONFIRM. 1:100 FALL MIN.

N7: COLORBOND PARAPET CAPPING TO FALL INWARDS. ON SLOPING HW BATTEN FIZED TO TOP OF WALL STRUCTURE

MATERIALS & FINISHES SCHEDULE

LOCKDEK OR SIMILAR

REFER TO DERBYSHIRE SPECIFICATION FOR COMPLETE SPECIFICATION OF MATERIALS & DETAILS OF FINISH.

ABBREVIATIONS


ROOF ANTENNA BARGE FLASHING & CAPPING BOX GUTTER COLORBOND CAPPING


DOWNPIPE FASCIA GUTTER

FEATURE WINDOS BOXING - ALUMINIUM 250X250MM GRATED SW PITS

BC
BG
CC
DP
FG
FWB
GSP
OP
PC
RL
SG
SPR
RWH OVERFLOW POP PARAPET CAPPING RFI ATIVE I EVEL SOAKER GUTTER SPREADER RAIN WHATER HEAD WALL/ROOF FLASHING

 $\langle XX \rangle$ MATERIAL

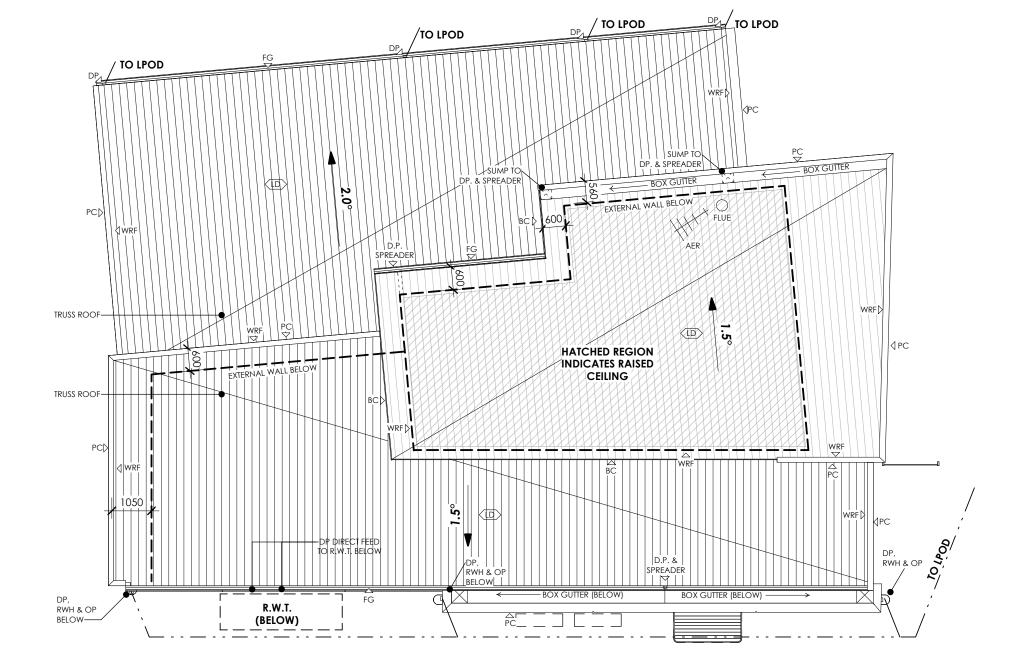

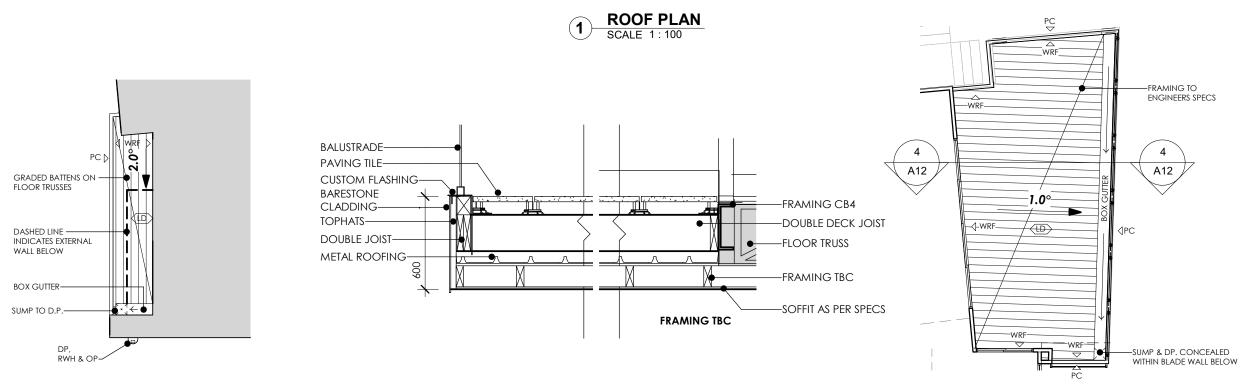





SECONDARY ROOF PLAN

NOTES ORIGINAL A3

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Е	05.09.19	WINDOWS	ALT	AR
F	12.09.19	NEIGHBOURS CONSENT	ALT	AR
G	19.09.19	LIFT RELOCATED	ALT	AR
Н	08.10.19	LIGHT POLE	ALT	AR
	01.11.19	BUILDING ENVELOPE	ALT	AR
J	11.11.19	FLOOR SET DOWN	ALT	AR

CLIENT

BRENDAN PETER BORG

PROJECT

LOT 09 (No. 15) CALIMO PLACE INDENTED HEAD 3223

DRAWING

ROOF PLAN

Derbyshire

DRAWN	CHECKED	SCALE
ALT	AR	VARIES
DATE	PROJECT No	STATUS
1.11.2019	G1811	CD
DRAWING No		REV
A12		

NOTES THESE PLANS SHALL BE READ IN CONJUNCTION WITH ANY STRUCTURAL OR CIVIL ENGINEERING COMPUTATIONS AND DRAWINGS; AND ALL OTHER CONSULTANTS DRAWINGS / DETAILS AND WITH ANY OTHER WRITTEN INSTRUCTIONS ISSUED IN THE COURSE OF THE CONTRACT. GLAZING, INCLUDING SAFETY GLAZING, SHALL BE INSTALLED TO A SIZE, TYPE AND THICKNESS SO AS TO COMPLY WITH:- BCA PART 3 FOR CLASS 1 AND 10 BUILDINGS WITHIN A DESIGN WIND SPEED OF NOT MORE THAN N3; AND - NCC 2019 BCA VOL 1 PART B1.4 FOR CLASS 2 AND 9 BUILDINGS. N3: THESE DRAWINGS SHALL BE READ IN CONJUNCTION WITH ANY HOUSE ENERGY RATING (HERS) REPORT AND SHALL BE CONSTRUCTED IN ACCORDANCE WITH THE STAMPED PLANS ENDORSED BY THE ACCREDITED THERMAL PERFORMANCE ASSESSOR WITHOUT ALTERATION WHERE REQUIRED TREAT AREA BENEATH FLOOR AGAINST TERMITE INFESTATION IN ACCORDANCE WITH RELEVANT STANDARD, CONTACT THE RELEVANT MUNICIPAL COUNCIL TO DETERMINE IF THIS IS MANDATORY REFER TO SCHEDULES FOR DIMENSIONED DOOR & WINDOW ELEVATIONS. WINDOW SIZES NOMINATED ARE NOMINAL ONLY. ACTUAL SIZES MAY VARY ACCORDING TO MANUFACTURER STEPS TO DECK. 190MM MAX. RISER. 250MM MIN. GOING TREADS REFER TO STRUCTURAL ENGINEERING DOCUMENTS FOR FOOTINGS & SLAB SPECIFICATION, FLOOR & WALL FRAMING. REFER TO ENERGY REPORT FOR NOMINATION OF ALL INSULATION **MATERIALS & FINISHES SCHEDULE** BARESTONE RENDERED FOAM LYSAGHT DOMINION BRICKWORK ALUCOBOND REFER TO DERBYSHIRE SPECIFICATION FOR COMPLETE SPECIFICATION OF MATERIALS & DETAILS OF FINISH.

ABBREVIATIONS

COL DP

EXH FCL FFL G

GAS IHW MB NGL

OP PC RL RWT

RWH

(XX)

XX

 $\langle XX \rangle$

BULKHEAD

DOWNPIPE

STEEL COLUMN

EXHAUST DUCT

SWINGING GATE

OVERFLOW POP

RAINWATER TANK

RAINWATER HEAD SPREADER

DOOR No.

WINDOW No

STRUCTURAL ENGINEERS DETAILS

MATERIAL

PARAPET CAPPING RELATIVE LEVEL

-ROOF SHEETING AS SPECIFIED, SARKING AND FLASHING AS REQUIRED TO ROOF WATERTIGHT -PREFABRICATED ROOF TRUSS AS PER MANUFACTURERS SPECIFICATIONS —INSULATION BATTS TO ROOF AS PER -BARGE CAPPING -RED DASHED LINE REPRESENTS 7.5M ABOVE NATURAL GROUND ROOF SHEETING AS SPECIFIED, SARKING AND FLASHING AS REQUIRED TO ROOF WATERTIGHT 4.5mm HARDIFLEX CEMENT -INSULATION BATTS TO EXTERNAL WALLS AS PER SPECIFICATION -PREFABRICATED ROOF TRUSS AS PER 1st C.L. RL.15760 mm MANUFACTURERS SPECIFICATIONS -PARAPET CAPPING (FW09) L1 -INSULATION BATTS TO ROOF AS PER SPECIFICATION RL. 14.500 m STUDY INTERIORS REFER A26 A1 1st F.L. RL.13060 mm LONG REACH FLOOR TRUSSES TO (GW09 (GW08) MANUFACTURERS DETAILS GRD C.L. RL.12600 mm -10mm PASTERBOARD WALL LINING TO BARGE FLASHING & CAPPING 10mm FLUSH P'BOARD TO U/S OF SELECTED ARCHITRAVES-16MM METAL TOPHAT BATTENS AT 450CTS MAX (RD01) FINISHED CEILING LEVEL FINISHED FLOOR LEVEL **GARAGE** EXTERNAL GAS OUTLET INSTANTANEOUS HOT WATER ELECTRICAL METERBOARD GD04 NATURAL GROUND LINE ______GRD F.L. RL. 9900 mm RL. 9.810 m RED DASHED LINE REPRESENTS NATURAL GROUND SLAB & CONCRETE FOOTINGS TO

NOTES ORIGINAL A3

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Notify Derbyshire Homes of any discrepancies. Drawings to be read in conjuction with specifications

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V	DATE	DESCRIPTION	DRN	CHKD
	14.05.19	CONSTRUCTION ISSUE	ALT	AR
	05.07.19	LIFT COORDINATION	ALT	AR
	09.07.19	NGL COORDINATION	ALT	AR
	23.08.19	HEIGHT + WINDOWS	ALT	AR
	02.09.19	17 CALIMO PL	ALT	AR
	05.09.19	WINDOWS	ALT	AR
	12.09.19	NEIGHBOURS CONSENT	ALT	AR
	19.09.19	LIFT RELOCATED	ALT	AR
	08.10.19	LIGHT POLE	ALT	AR
	01.11.19	BUILDING ENVELOPE	ALT	AR
	11.11.19	FLOOR SET DOWN	ALT	AR

CLIENT

BRENDAN PETER BORG

PROJECT

LOT 09 (No. 15) CALIMO PLACE INDENTED HEAD 3223

DRAWING

SECTION 1/1

Derbyshire

Address: 98 Pakington St, Geelong West VIC 3218 Phone: (03) 5221 8409

DRAWN CHECKED SCALE ALT AR 1:50 DATE STATUS PROJECT No 1.11.2019 G1811 CD DRAWING No REV A13

THESE PLANS SHALL BE READ IN CONJUNCTION WITH ANY STRUCTURAL OR CIVIL ENGINEERING COMPUTATIONS AND DRAWINGS; AND ALL OTHER CONSULTANTS DRAWINGS / DETAILS AND WITH ANY OTHER WRITTEN INSTRUCTIONS ISSUED IN THE COURSE OF THE CONTRACT.

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WHERE REQUIRED TREAT AREA BENEATH FLOOR AGAINST TERMITE INFESTATION IN ACCORDANCE WITH RELEVANT STANDARD, CONTACT THE RELEVANT MUNICIPAL COUNCIL TO DETERMINE IF THIS IS MANDATORY

REFER TO SCHEDULES FOR DIMENSIONED DOOR & WINDOW ELEVATIONS. WINDOW SIZES NOMINATED ARE NOMINAL ONLY. ACTUAL SIZES MAY VARY ACCORDING TO MANUFACTURER

STEPS TO DECK. 190MM MAX. RISER. 250MM MIN. GOING TREADS

REFER TO STRUCTURAL ENGINEERING DOCUMENTS FOR FOOTINGS & SLAB SPECIFICATION, FLOOR & WALL FRAMING.

REFER TO ENERGY REPORT FOR NOMINATION OF ALL INSULATION

MATERIALS & FINISHES SCHEDULE

BARESTONE RENDERED FOAM LYSAGHT DOMINION BRICKWORK ALUCOBOND

REFER TO DERBYSHIRE SPECIFICATION FOR COMPLETE SPECIFICATION OF MATERIALS & DETAILS OF FINISH.

ABBREVIATIONS

BULKHEAD BARGE FLASHING & CAPPING BC COL STEEL COLUMN DOWNPIPE EXHAUST DUCT DP EXH FINISHED CEILING LEVEL

FCL FFL G GAS FINISHED FLOOR LEVEL SWINGING GATE EXTERNAL GAS OUTLET
INSTANTANEOUS HOT WATER IHW MB NGL ELECTRICAL METERBOARD NATURAL GROUND LINE OP PC RL RWT OVERFLOW POP PARAPET CAPPING RFI ATIVE I FVFI RAINWATER TANK


RWH RAINWATER HEAD SHR SP SHOWER SPREADER

DOOR No.



WINDOW No.

 $\langle XX \rangle$ MATERIAL

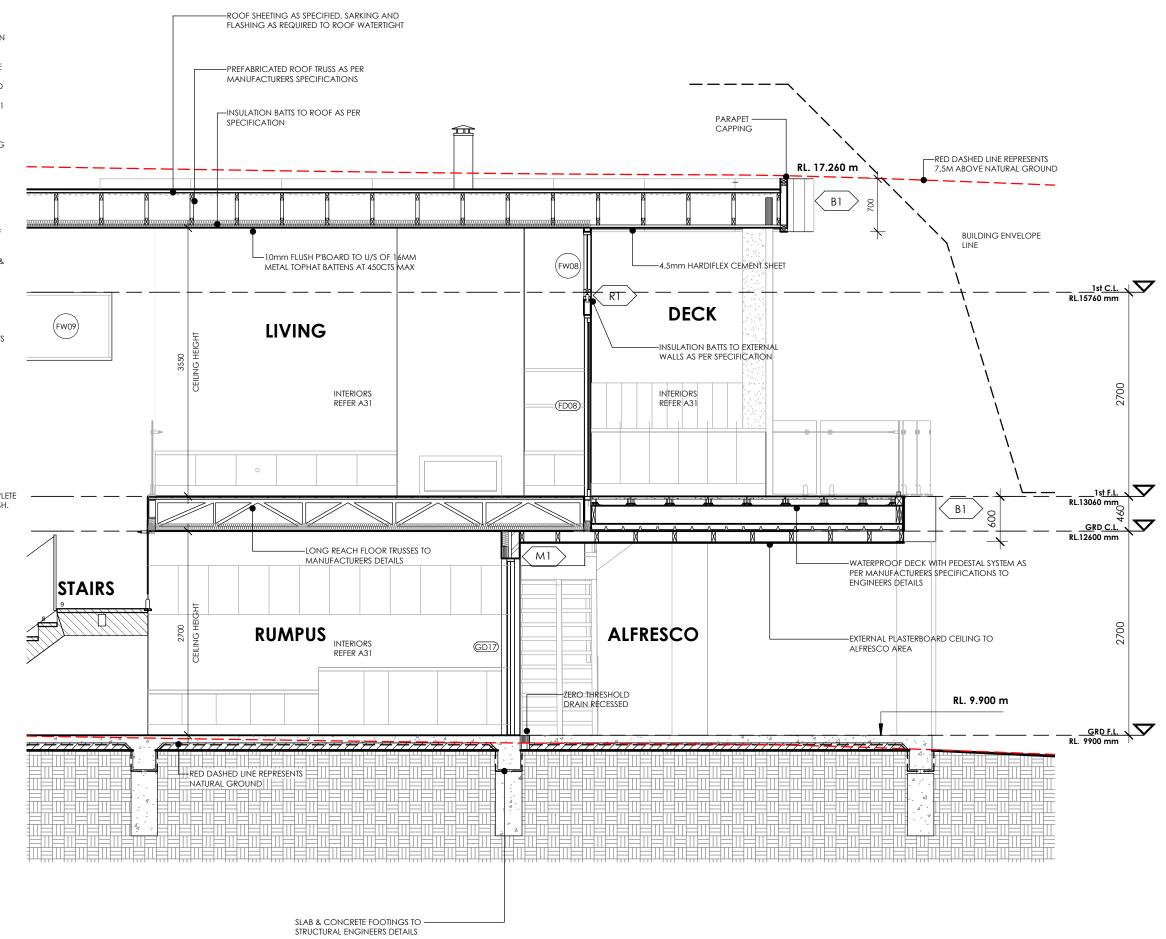

NOTES ORIGINAL A3

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	J F	11-5	,	
V	DATE	DESCRIPTION	DRN	CHKD
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	08.10.19	LIGHT POLE	ALT	AR
	01.11.19	BUILDING ENVELOPE	ALT	AR
	11.11.19	FLOOR SET DOWN	ALT	AR

CLIENT

BRENDAN PETER BORG

PROJECT

LOT 09 (No. 15) CALIMO PLACE INDENTED HEAD 3223

DRAWING

SECTION 2/1

Derbyshire

DRAWN	CHECKED	SCALE
ALT	AR	1:50
DATE	PROJECT No	STATUS
1.11.2019	G1811	CD
DRAWING No		REV
A14		

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STEPS TO DECK. 190MM MAX. RISER. 250MM MIN.

GOING TREADS

REFER TO STRUCTURAL ENGINEERING DOCUMENTS FOR FOOTINGS & SLAB SPECIFICATION, FLOOR & WALL FRAMING.

REFER TO ENERGY REPORT FOR NOMINATION OF ALL INSULATION.

MATERIALS & FINISHES SCHEDULE

BARESTONE RENDERED FOAM LYSAGHT DOMINION BRICKWORK ALUCOBOND

REFER TO DERBYSHIRE SPECIFICATION FOR COMPLETE SPECIFICATION OF MATERIALS & DETAILS OF FINISH.

ABBREVIATIONS

BULKHEAD

BARGE FLASHING & CAPPING

BC COL DP EXH STEEL COLUMN DOWNPIPE EXHAUST DUCT FINISHED CEILING LEVEL

FCL FFL G GAS FINISHED FLOOR LEVEL SWINGING GATE EXTERNAL GAS OUTLET INSTANTANEOUS HOT WATER IHW MB NGL ELECTRICAL METERBOARD
NATURAL GROUND LINE OP PC RL RWT OVERFLOW POP PARAPET CAPPING RFI ATIVE I FVFI


RWH RAINWATER HEAD SHR SP SHOWER SPREADER

(XX)DOOR No.



WINDOW No.

 $\langle XX \rangle$ MATERIAL

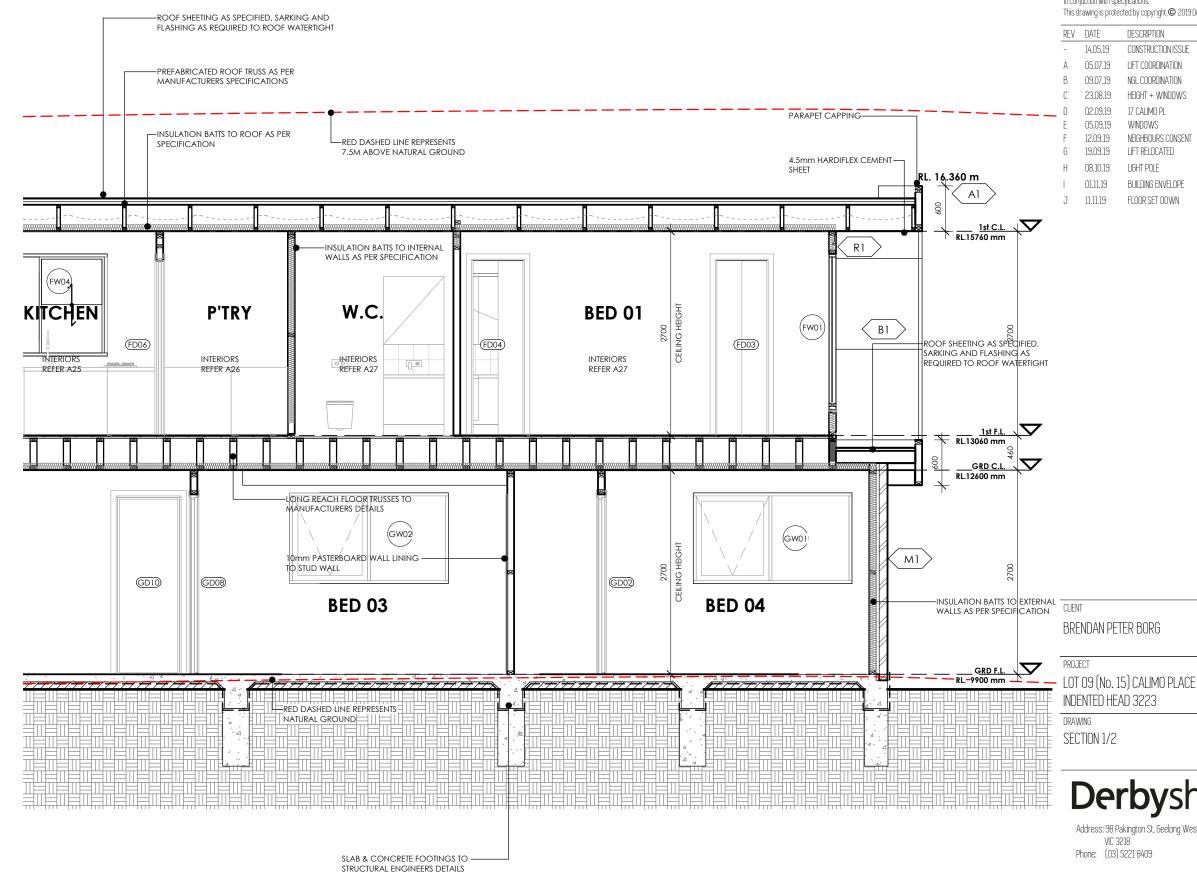

NOTES ORIGINAL A3

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V	DATE	DESCRIPTION	DRN	CHKD
	14.05.19	CONSTRUCTION ISSUE	ALT	AR
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	02.09.19	17 CALIMO PL	ALT	AR
	05.09.19	WINDOWS	ALT	AR
	12.09.19	NEIGHBOURS CONSENT	ALT	AR
	19.09.19	LIFT RELOCATED	ALT	AR
	08.10.19	LIGHT POLE	ALT	AR
	01.11.19	BUILDING ENVELOPE	ALT	AR
	11.11.19	FLOOR SET DOWN	ALT	AR

SECTION 1/2

Derbyshire

Address: 98 Pakington St, Geelong West VIC 3218 Phone: (03) 5221 8409

DRAWN CHECKED SCALE ALT AR 1:50 DATE STATUS PROJECT No 1.11.2019 G1811 CD DRAWING No REV A15

THESE PLANS SHALL BE READ IN CONJUNCTION WITH ANY STRUCTURAL OR CIVIL ENGINEERING COMPUTATIONS AND DRAWINGS; AND ALL OTHER CONSULTANTS DRAWINGS / DETAILS AND WITH ANY OTHER WRITTEN INSTRUCTIONS ISSUED IN THE COURSE OF THE CONTRACT.

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STEPS TO DECK. 190MM MAX. RISER. 250MM MIN.

GOING TREADS

REFER TO STRUCTURAL ENGINEERING DOCUMENTS FOR FOOTINGS & SLAB SPECIFICATION, FLOOR & WALL FRAMING.

REFER TO ENERGY REPORT FOR NOMINATION OF ALL INSULATION.

MATERIALS & FINISHES SCHEDULE

BARESTONE RENDERED FOAM LYSAGHT DOMINION BRICKWORK ALUCOBOND

REFER TO DERBYSHIRE SPECIFICATION FOR COMPLETE SPECIFICATION OF MATERIALS & DETAILS OF FINISH.

ABBREVIATIONS

BULKHEAD

BARGE FLASHING & CAPPING STEEL COLUMN

BC COL DOWNPIPE EXHAUST DUCT DP EXH

FCL FFL G FINISHED CEILING LEVEL FINISHED FLOOR LEVEL SWINGING GATE EXTERNAL GAS OUTLET
INSTANTANEOUS HOT WATER GAS

IHW MB NGL ELECTRICAL METERBOARD NATURAL GROUND LINE OP PC RL RWT OVERFLOW POP PARAPET CAPPING

RFI ATIVE I FVFI RAINWATER TANK RWH RAINWATER HEAD


SHR SP SHOWER SPREADER

(XX)DOOR No.

XX

WINDOW No.

 $\langle XX \rangle$ MATERIAL

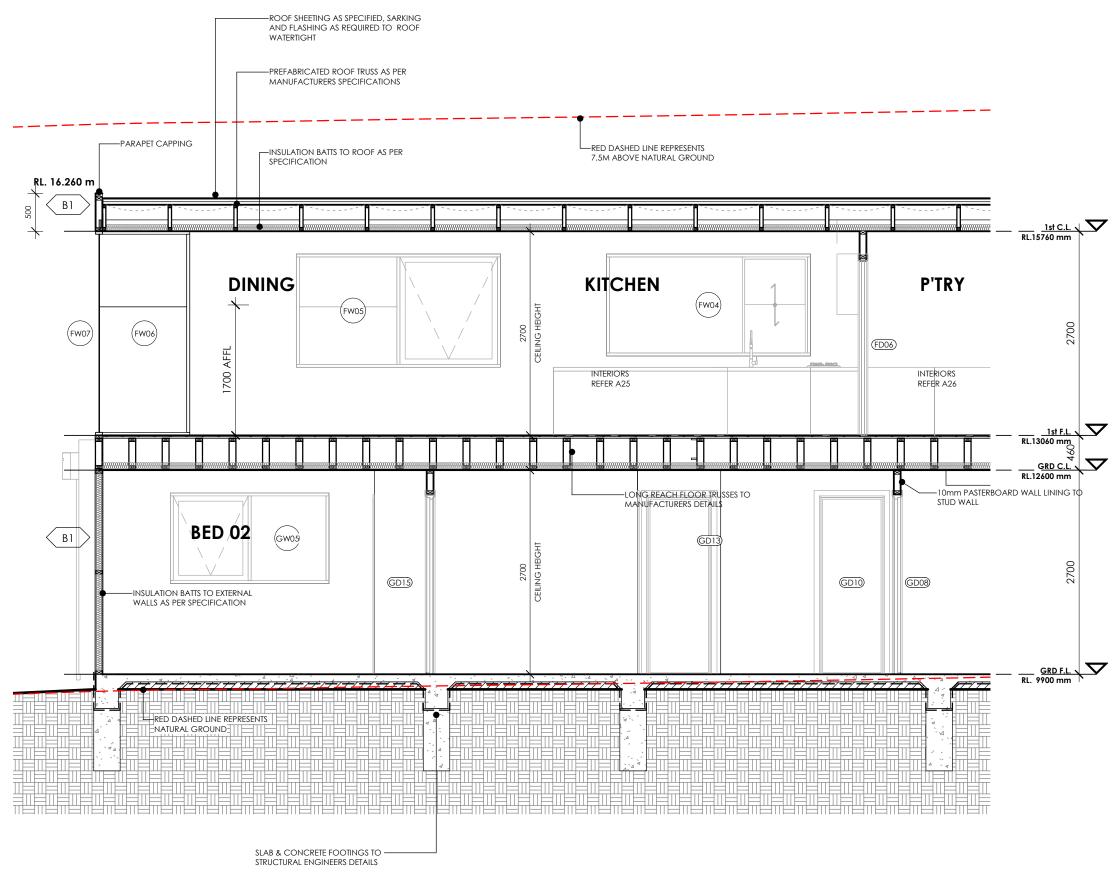

NOTES ORIGINAL A3

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V	DATE	DESCRIPTION	DRN	CHKD
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	05.07.19	LIFT COORDINATION	ALT	AR
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	19.09.19	LIFT RELOCATED	ALT	AR
	08.10.19	LIGHT POLE	ALT	AR
	01.11.19	BUILDING ENVELOPE	ALT	AR
	11.11.19	FLOOR SET DOWN	ALT	AR

CLIENT

BRENDAN PETER BORG

PROJECT


LOT 09 (No. 15) CALIMO PLACE INDENTED HEAD 3223

DRAWING

SECTION 2/2

Derbyshire

DRAWN	CHECKED	SCALE
ALT	AR	1:50
DATE	PROJECT No	STATUS
1.11.2019	G1811	CD
DRAWING No		REV
A16		

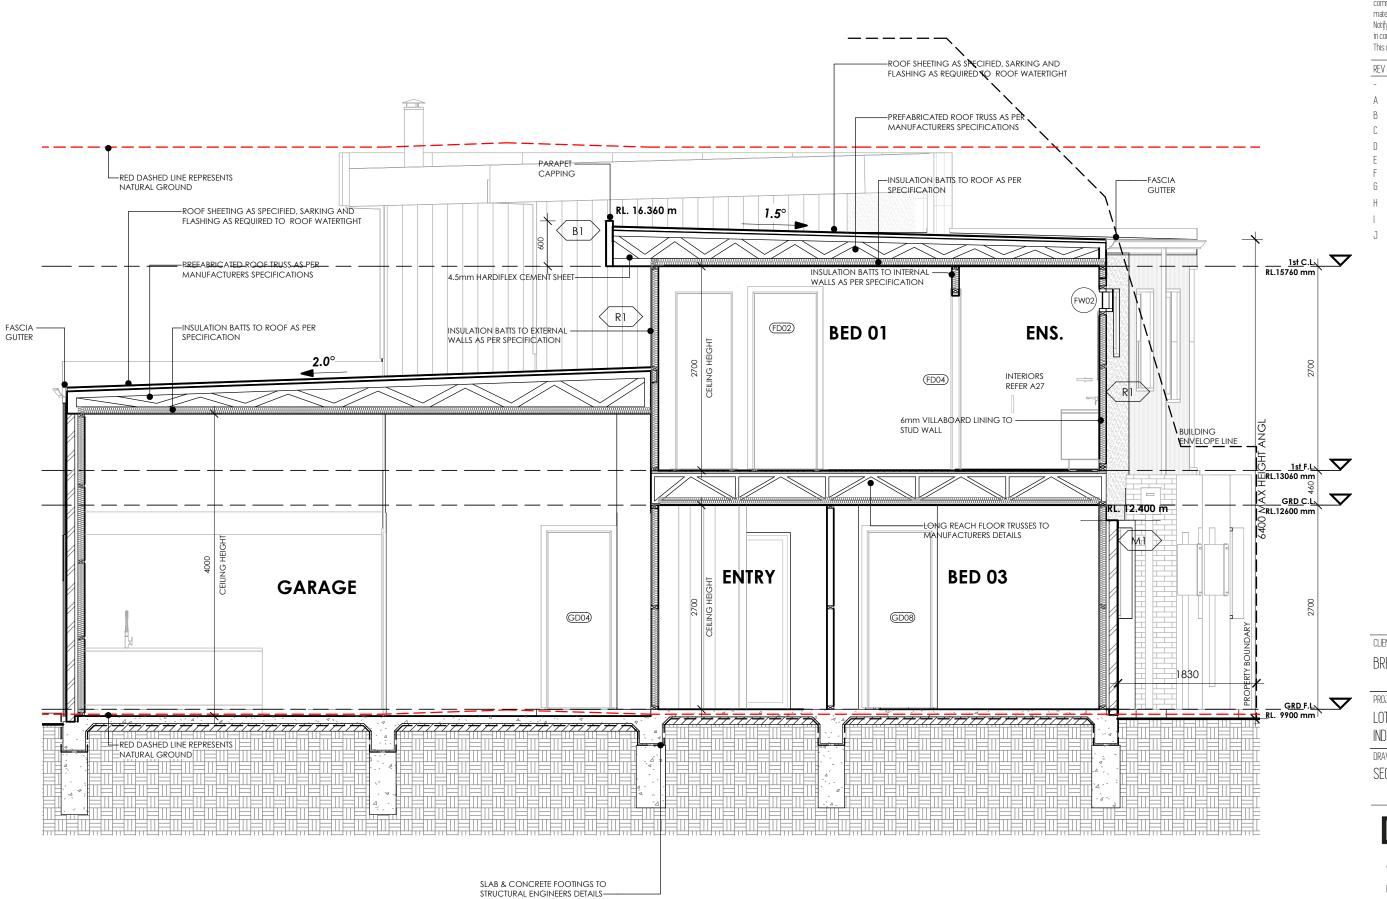

NOTES ORIGINAL A3

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EV	DATE	DESCRIPTION	DRN	CHKD
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ı	05.07.19	LIFT COORDINATION	ALT	AR
i	09.07.19	NGL COORDINATION	ALT	AR
	23.08.19	HEIGHT + WINDOWS	ALT	AR
	02.09.19	17 CALIMO PL	ALT	AR
	05.09.19	WINDOWS	ALT	AR
	12.09.19	NEIGHBOURS CONSENT	ALT	AR
	19.09.19	LIFT RELOCATED	ALT	AR
	08.10.19	LIGHT POLE	ALT	AR
	01.11.19	BUILDING ENVELOPE	ALT	AR
	11.11.19	FLOOR SET DOWN	ALT	AR

CLIENT

BRENDAN PETER BORG

PROJECT


LOT 09 (No. 15) CALIMO PLACE INDENTED HEAD 3223

DRAWING

SECTION 3

Derbyshire

DRAWN	CHECKED	SCALE
ALT	AR	
DATE	PROJECT No	STATUS
1.11.2019	G1811	CD
DRAWING No		REV
A17		

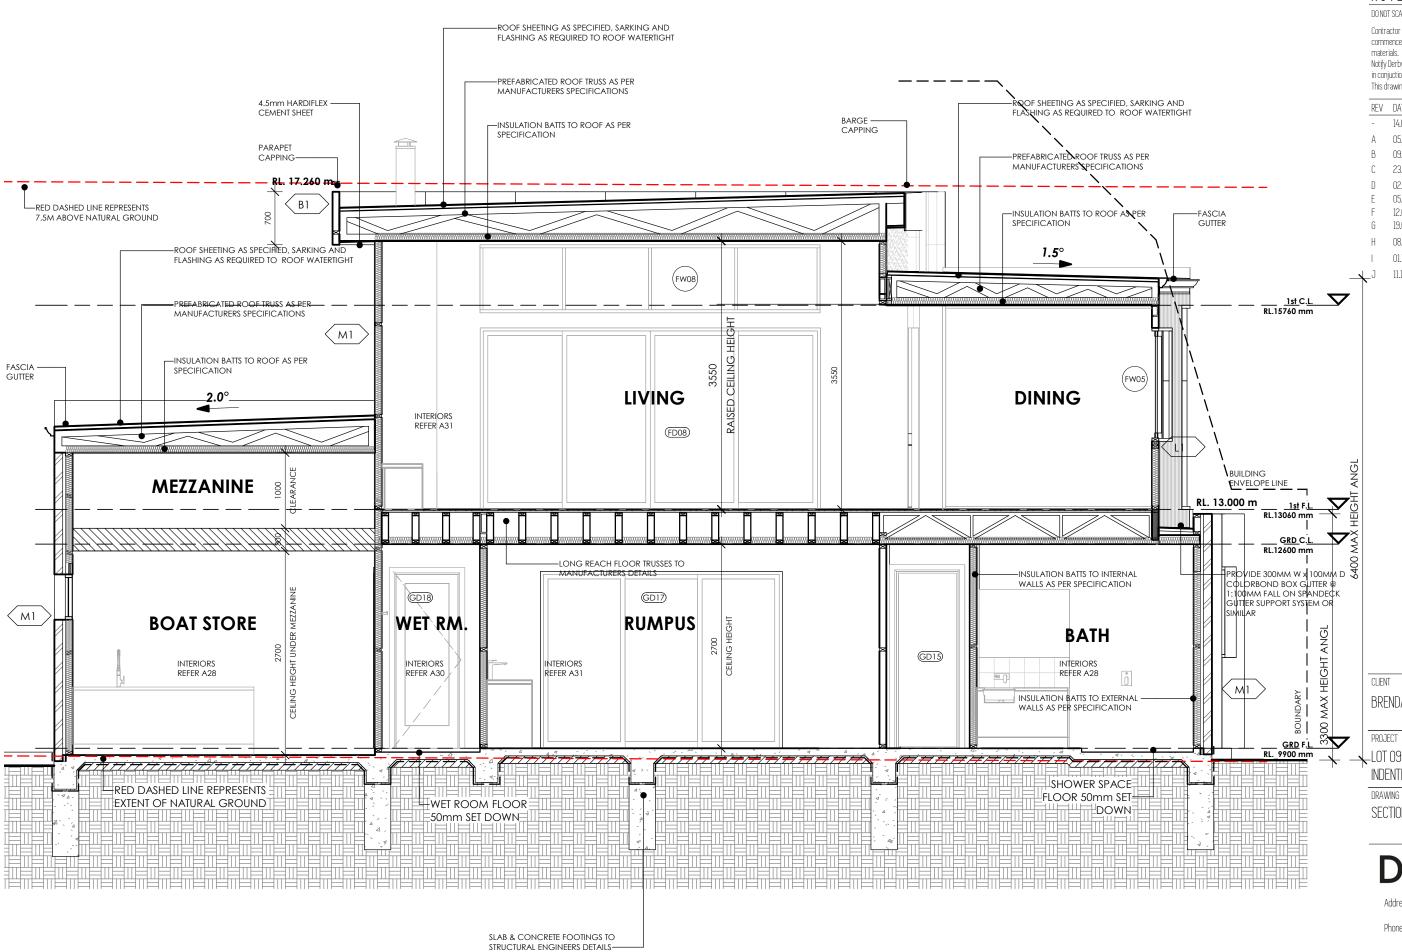

NOTES ORIGINAL A3

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EV	DATE	DESCRIPTION	DRN	CH
	14.05.19	CONSTRUCTION ISSUE	ALT	AR
١	05.07.19	LIFT COORDINATION	ALT	AR
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	02.09.19	17 CALIMO PL	ALT	AR
	05.09.19	WINDOWS	ALT	${\sf AR}$
	12.09.19	NEIGHBOURS CONSENT	ALT	AR
i	19.09.19	LIFT RELOCATED	ALT	AR
	08.10.19	LIGHT POLE	ALT	AR
	01.11.19	BUILDING ENVELOPE	ALT	AR
l	11.11.19	FLOOR SET DOWN	ALT	AR

BRENDAN PETER BORG

LOT 09 (No. 15) CALIMO PLACE INDENTED HEAD 3223

SECTION 4

Derbyshire

DRAWN	CHECKED	SCALE
ALT	AR	
DATE	PROJECT No	STATUS
1.11.2019	G1811	CD
DRAWING No		REV
A18		

GLAZING, INCLUDING SAFETY GLAZING, SHALL BE INSTALLED TO A SIZE, TYPE AND THICKNESS SO AS TO COMPLY WITH:- BCA PART 3 FOR CLASS 1 AND 10 BUILDINGS WITHIN A DESIGN WIND SPEED OF NOT MORE THAN N3; AND - NCC 2019 BCA VOL 1 PART B1.4 FOR CLASS 2 AND 9 BUILDINGS.SAFETY GLASS TO BE USED IN THE FOLLOWING CASES: I) ALL ROOMS – WITHIN 500mm VERTICAL OF THE

II) BATHROOMS – WITHIN 2000mm OF THE FLOOR.

III) BATHROOMS – WITHIN 2000mm OF THE FLOOR.

III) LAUNDRY – WITHIN 1200mm VERTICAL FROM FLOOR AND/OR WITHIN 300mm HORIZONTAL FROM ALL DOORS.

IV) DOORWAY – WITHIN 300mm HORIZONTAL FROM DOORS.

SHOWER SCREENS SHALL BE GRADE A SAFETY GLASS.

THESE DRAWINGS SHALL BE READ IN CONJUNCTION WITH ANY HOUSE ENERGY RATING (HERS) REPORT AND SHALL BE CONSTRUCTED IN ACCORDANCE WITH THE STAMPED PLANS ENDORSED BY THE ACCREDITED THERMAL PERFORMANCE ASSESSOR WITHOUT ALTERATION

DOOR SIZES NOMINATED ARE NOMINAL ONLY.
ACTUAL SIZES MAY VARY ACCORDING TO

MANUFACTURER

W.C. DOORS TO TOILET PANS LOCATED WITHIN 1.2m OF THE DOOR JAMB LIFT OFF HINGES MUST BE FITTED. OTHERWISE THE DOORS MUST SWING

ALL WINDOWS AND DOORS TO BE SITE MEASURED PRIOR TO MANUFACTURER / ORDER.

ALL WINDOWS & DOORS TO BE IN ACCORDANCE WITH AS1288-2011

PROVIDE DOOR THRESHOLD TO ALL EXTERNAL DOORS

ALL DOORS & WINDOWS VIEWED FROM OUTSIDE UNLESS NOTED OTHERWISE

PROVIDE LOCKS TO ALL OPENABLE WINDOWS

AND EXTERNAL DOORS N10: ALLOW FOR WEATHER SEALS TO ALL EDGES OF

OPENING WINDOW SASHES AND DOORS.

HARDWARE & FURNITURE TO BE CONFIRMED BY CLIENT.

MATERIALS & FINISHES SCHEDULE

PAINTED MDF

REFER TO DERBYSHIRE SPECIFICATION FOR COMPLETE SPECIFICATION OF MATERIALS & DETAILS OF FINISH.

ABBREVIATIONS

CAVITY SLIDING DOOR CLEAR GLAZING FIXED PANEL OBSCURE GLAZING SLIDING DOOR

DOOR SCHEDULE	DOOR SCHEDULE						
ID	GD01	GD02	GD03	GD04	GD05	GD06	
Location	ENTRY	BED 04	BED 04	GARAGE	BOAT STORE / STORE	BOAT STORE / ALFRESCO	
Height	2,340	2,340	2,340	2,340	2,340	2,340	
Width	1,200	820	2,100	820	2/820	820	
Elevation	1200	820	2340	820	1640	820	
Orientation	SOUTH WEST	N/A	N/A	N/A	N/A	SOUTH EAST	
Door Leaf Type	FLUSH PANEL	FLUSH PANEL	MDF DOORS X 2	FLUSH PANEL	FLUSH PANEL	ALUMINIUM & GLAZED	
Frame Type	TIMBER	TIMBER	ALUMINIUM TRACK	TIMBER	TIMBER	ALUMINIUM	
Frame Finish	PAINT	PAINT	POWDERCOAT COLOUR	PAINT PAINT		POWDERCOATED - MONUMENT	
Hardware	AS SPECIFIED	AS SPECIFIED	-	AS SPECIFIED	AS SPECIFIED	AS SPECIFIED	
Operation Type	SWINGING	SWINGING	SLIDING	SWINGING	CAVITY SLIDER	SWINGING	
Glazing	N/A	N/A	N/A	N/A	N/A	REFER TO ENERGY REPORT	
Extras					LOCKABLE		
Comments	SOLID CORE	SOLID CORE		SOLID CORE			

DOOR SCHEDULE		E.				
ID	GD07	GD08	GD09	GD10	GD11	
ocation.	RUMPUS	BED 03	BED 03	LAUNDRY	LAUNDRY	
Height	2,340	2,340	2,340	2,340	2,340	
Width	2/720	820	2,100	820	2,700	
Elevation	1440	820	2340	820	2700 QF ES	
Orientation	N/A	N/A	N/A	N/A	N/A	
oor Leaf Type	FLUSH PANEL	FLUSH PANEL MDF DOORS X 2		FLUSH PANEL	MDF DOORS X 3	
rame Type	TIMBER	TIMBER ALUMINIUM TRACK		TIMBER	ALUMINIUM TRACK	
rame Finish	PAINT	PAINT	POWDERCOAT COLOUR	PAINT	POWDERCOAT COLOUR	
ardware	AS SPECIFIED	AS SPECIFIED	-	AS SPECIFIED	-	
peration Type	CAVITY SLIDER	SWINGING	SLIDING	SWINGING	SLIDING	
Blazing	N/A	N/A	N/A	N/A	N/A	
xtras						
Comments	SOLID CORE	SOLID CORE		SOLID CORE		

NOTES ORIGINAL A3

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	01.11.19	BUILDING ENVELOPE	ALT	AR
J	11.11.19	FLOOR SET DOWN	ALT	AR

CLIENT

BRENDAN PETER BORG

PROJECT

LOT 09 (No. 15) CALIMO PLACE INDENTED HEAD 3223

DRAWING

DOOR SCHEDULE 1/3

Derbyshire

DRAWN	CHECKED	SCALE
ALT	AR	1:50
DATE	PROJECT No	STATUS
1.11.2019	G1811	CD
DRAWING No		REV
A19		

GLAZING, INCLUDING SAFETY GLAZING, SHALL BE INSTALLED TO A SIZE, TYPE AND THICKNESS SO AS TO COMPLY WITH:- BCA PART 3 FOR CLASS 1 AND 10 BUILDINGS WITHIN A DESIGN WIND SPEED OF NOT MORE THAN N3; AND - NCC 2019 BCA VOL 1 PART B1.4 FOR CLASS 2 AND 9 BUILDINGS.SAFETY GLASS TO BE USED IN THE FOLLOWING CASES: I) ALL ROOMS – WITHIN 500mm VERTICAL OF THE

II) BATHROOMS – WITHIN 2000mm OF THE FLOOR.

III) BATHROOMS – WITHIN 2000mm OF THE FLOOR.

III) LAUNDRY – WITHIN 1200mm VERTICAL FROM FLOOR AND/OR WITHIN 300mm HORIZONTAL FROM ALL DOORS.

IV) DOORWAY – WITHIN 300mm HORIZONTAL FROM DOORS.

SHOWER SCREENS SHALL BE GRADE A SAFETY GLASS.

THESE DRAWINGS SHALL BE READ IN CONJUNCTION WITH ANY HOUSE ENERGY RATING (HERS) REPORT AND SHALL BE CONSTRUCTED IN ACCORDANCE WITH THE STAMPED PLANS ENDORSED BY THE ACCREDITED THERMAL PERFORMANCE ASSESSOR WITHOUT ALTERATION

DOOR SIZES NOMINATED ARE NOMINAL ONLY. ACTUAL SIZES MAY VARY ACCORDING TO

MANUFACTURER

W.C. DOORS TO TOILET PANS LOCATED WITHIN 1.2m OF THE DOOR JAMB LIFT OFF HINGES MUST BE FITTED. OTHERWISE THE DOORS MUST SWING

ALL WINDOWS AND DOORS TO BE SITE MEASURED

PRIOR TO MANUFACTURER / ORDER.

ALL WINDOWS & DOORS TO BE IN ACCORDANCE WITH AS1288-2011

PROVIDE DOOR THRESHOLD TO ALL EXTERNAL DOORS

ALL DOORS & WINDOWS VIEWED FROM OUTSIDE UNLESS NOTED OTHERWISE

PROVIDE LOCKS TO ALL OPENABLE WINDOWS AND EXTERNAL DOORS N10:

ALLOW FOR WEATHER SEALS TO ALL EDGES OF OPENING WINDOW SASHES AND DOORS.

HARDWARE & FURNITURE TO BE CONFIRMED BY CLIENT.

MATERIALS & FINISHES SCHEDULE

PAINTED MDF

REFER TO DERBYSHIRE SPECIFICATION FOR COMPLETE SPECIFICATION OF MATERIALS & DETAILS OF FINISH.

ABBREVIATIONS

CSD CAVITY SLIDING DOOR CLEAR GLAZING FIXED PANEL OG SD OBSCURE GLAZING SLIDING DOOR

DOOR SCHEDULE						
ID	GD12	GD13	GD14	GD15	GD16	GD18
Location	LAUNDRY	POWDER ROOM	BATHROOM	BED 02	BED 02	WET ROOM
Height	2,340	2,340	2,340	2,340	2,340	2,340
Width	820	820	820	820	2,700	820
Elevation	8340	0,652	820	820	2700 QF EZ	2340
Orientation	SOUTH EAST	N/A	N/A	N/A	N/A	NORTH EAST
Door Leaf Type	ALUMINIUM & GLAZED	FLUSH PANEL	FLUSH PANEL	FLUSH PANEL	MDF DOORS X 3	ALUMINIUM & GLAZED
Frame Type	ALUMINIUM	TIMBER	TIMBER	TIMBER	ALUMINIUM TRACK	ALUMINIUM
Frame Finish	POWDERCOATED - MONUMENT	PAINT	PAINT	PAINT	POWDERCOAT COLOUR	POWDERCOATED - MONUMENT
Hardware	AS SPECIFIED	AS SPECIFIED	AS SPECIFIED	AS SPECIFIED	-	AS SPECIFIED
Operation Type	SWINGING	SWINGIN SWINGING SWINGING SLIDING		SLIDING	SWINGING	
Glazing	REFER TO ENERGY REPORT		N/A	N/A	N/A	REFER TO ENERGY REPORT
Extras						
Comments				SOLID CORE		

DOOR SCHEDULE						
ID	GD17	FD01	FD02	FD03	FD04	FD05
Location	RUMPUS / ALFRESCO	LINEN	BED 01	BED 01	BED 01	WC
Height	2,340	2,340	2,340	2,340	2,340	2,340
Width	3,200	720	820	720	720	820
Elevation	3200	7340	8340	720	000	820
Orientation	NORTH EAST	N/A	N/A	N/A	N/A	N/A
Door Leaf Type	ALUMINIUM & GLAZED	FLUSH PANEL	FLUSH PANEL	FLUSH PANEL	FLUSH PANEL	FLUSH PANEL
Frame Type	ALUMINIUM	TIMBER	TIMBER	TIMBER	TIMBER	TIMBER
Frame Finish	POWDERCOATED - MONUMENT	PAINT	PAINT	PAINT	PAINT	PAINT
Hardware	AS SPECIFIED	AS SPECIFIED	AS SPECIFIED	AS SPECIFIED	AS SPECIFIED	AS SPECIFIED
Operation Type	SLIDING	SWINGING	SWINGING	CAVITY SLIDER	CAVITY SLIDER	SWINGING
Glazing	REFER TO ENERGY REPORT	N/A	N/A	N/A	N/A	N/A
Extras						
Comments			SOLID CORE			

NOTES ORIGINAL A3

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REV	DATE	DESCRIPTION	DRN	CHK
-	14.05.19	CONSTRUCTION ISSUE	ALT	AR
Α	05.07.19	LIFT COORDINATION	ALT	AR
В	09.07.19	NGL COORDINATION	ALT	AR
C	23.08.19	HEIGHT + WINDOWS	ALT	AR
D	02.09.19	17 CALIMO PL	ALT	AR
E	05.09.19	WINDOWS	ALT	AR
F	12.09.19	NEIGHBOURS CONSENT	ALT	AR
G	19.09.19	LIFT RELOCATED	ALT	AR
Н	08.10.19	LIGHT POLE	ALT	AR
1	01.11.19	BUILDING ENVELOPE	ALT	AR
J	11.11.19	FLOOR SET DOWN	ALT	AR

CLIENT

BRENDAN PETER BORG

PROJECT

LOT 09 (No. 15) CALIMO PLACE INDENTED HEAD 3223

DRAWING

DOOR SCHEDULE 2/3

Derbyshire

DRAWN	CHECKED	SCALE
ALT	AR	1:50
DATE	PROJECT No	STATUS
1.11.2019	G1811	CD
DRAWING No		REV
A20		

GLAZING, INCLUDING SAFETY GLAZING, SHALL BE INSTALLED TO A SIZE, TYPE AND THICKNESS SO AS TO COMPLY WITH:- BCA PART 3 FOR CLASS 1 AND 10 BUILDINGS WITHIN A DESIGN WIND SPEED OF NOT MORE THAN N3; AND - NCC 2019 BCA VOL 1 PART B1.4 FOR CLASS 2 AND 9 BUILDINGS.SAFETY GLASS TO BE USED IN THE FOLLOWING CASES: I) ALL ROOMS – WITHIN 500mm VERTICAL OF THE FLOOR.

II) BATHROOMS – WITHIN 2000mm OF THE FLOOR.

II) BATHROOMS – WITHIN 2000mm OF THE FLOOR.
III) LAUNDRY – WITHIN 1200mm VERTICAL FROM
FLOOR AND/OR WITHIN 300mm HORIZONTAL
FROM ALL DOORS.

IV) DOORWAY – WITHIN 300mm HORIZONTAL FROM DOORS.

SHOWER SCREENS SHALL BE GRADE A SAFETY

GLASS.

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CONJUNCTION WITH ANY HOUSE ENERGY RATING
(HERS) REPORT AND SHALL BE CONSTRUCTED IN
ACCORDANCE WITH THE STAMPED PLANS
ENDORSED BY THE ACCREDITED THERMAL
PERFORMANCE ASSESSOR WITHOUT ALTERATION

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ACTUAL SIZES MAY VARY ACCORDING TO MANUFACTURER NA:
W.C. DOORS TO TOILET PANS LOCATED WITHIN

1.2m OF THE DOOR JAMB LIFT OFF HINGES MUST BE FITTED. OTHERWISE THE DOORS MUST SWING OUTWARDS.

N5:
ALL WINDOWS AND DOORS TO BE SITE MEASURED PRIOR TO MANUFACTURER / ORDER.

N6: ALL WINDOWS & DOORS TO BE IN ACCORDANCE

WITH AS1288-2011

PROVIDE DOOR THRESHOLD TO ALL EXTERNAL DOORS

N8: ALL DOORS & WINDOWS VIEWED FROM OUTSIDE UNLESS NOTED OTHERWISE

PROVIDE LOCKS TO ALL OPENABLE WINDOWS AND EXTERNAL DOORS
N10:

ALLOW FOR WEATHER SEALS TO ALL EDGES OF OPENING WINDOW SASHES AND DOORS.

N11:

DOOR SCHEDINE

HARDWARE & FURNITURE TO BE CONFIRMED BY CLIENT.

MATERIALS & FINISHES SCHEDULE

F PAINTED MDF

REFER TO DERBYSHIRE SPECIFICATION FOR COMPLETE SPECIFICATION OF MATERIALS & DETAILS OF FINISH.

ABBREVIATIONS

CSD CAVITY SLIDING DOOR
CG CLEAR GLAZING
F FIXED PANEL
OG OBSCURE GLAZING
SD SLIDING DOOR

DOOR SCHEDULE					
ID	FD06	FD07	FD08		
Location	PANTRY	SUNROOM / DECK	LIVING / DECK		
Height	2,340	2,340	2,340		
Width	820	1,500	4,500		
Elevation	820 V 2	7 7 7	4500		
Orientation	N/A	NORTH WEST	NORTH EAST		
Door Leaf Type	FLUSH PANEL	ALUMINIUM & GLAZED	ALUMINIUM & GLAZED		
Frame Type	TIMBER	ALUMINIUM	ALUMINIUM		
Frame Finish	PAINT	POWDERCOATED - MONUMENT	POWDERCOATED - MONUMENT		
Hardware	AS SPECIFIED	AS SPECIFIED	AS SPECIFIED		
Operation Type	CAVITY SLIDER	SLIDING	SLIDING		
Glazing	N/A	REFER TO ENERGY REPORT	REFER TO ENERGY REPORT		
Extras					
Comments					

DOOR SCHEDULE			
ID	RD01	RD02	
Location	GARAGE	BOAT STORE	
Height	3,600	2,400	
Width	6,000	3,600	
Elevation	6000	3610	
Orientation			
Door Leaf Type	LINE SECTIONAL	LINE SECTIONAL	
Frame Type	STEEL	STEEL	
Frame Finish	PAINT - MONUMENT	PAINT - MONUMENT	
Hardware	AS SPECIFIED	AS SPECIFIED	
Operation Type	SECTIONAL DOOR	ROLLER	
Extras			
Comments			

NOTES ORIGINAL A3

DO NOT SCALE DRAWINGS - REFER ONLY TO WRITTEN DIMESIONS

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REV	DATE	DESCRIPTION	DRN	CHKD
-	14.05.19	CONSTRUCTION ISSUE	ALT	AR
Α	05.07.19	LIFT COORDINATION	ALT	AR
В	09.07.19	NGL COORDINATION	ALT	AR
C	23.08.19	HEIGHT + WINDOWS	ALT	AR
D	02.09.19	17 CALIMO PL	ALT	AR
Е	05.09.19	WINDOWS	ALT	AR
F	12.09.19	NEIGHBOURS CONSENT	ALT	AR
G	19.09.19	LIFT RELOCATED	ALT	AR
Н	08.10.19	LIGHT POLE	ALT	AR
1	01.11.19	BUILDING ENVELOPE	ALT	AR
J	11.11.19	FLOOR SET DOWN	ALT	AR

CLIENT

BRENDAN PETER BORG

PROJECT

LOT 09 (No. 15) CALIMO PLACE INDENTED HEAD 3223

DRAWING

DOOR SCHEDULE 3/3

Derbyshire

DRAWN	CHECKED	SCALE
ALT	AR	1:50
DATE	PROJECT No	STATUS
1.11.2019	G1811	CD
DRAWING No		REV
A21		

GLAZING, INCLUDING SAFETY GLAZING, SHALL BE INSTALLED TO A SIZE, TYPE AND THICKNESS SO AS TO COMPLY WITH:- BCA PART 3 FOR CLASS 1 AND 10 BUILDINGS WITHIN A DESIGN WIND SPEED OF NOT MORE THAN N3; AND - NCC 2019 BCA VOL 1 PART B1.4 FOR CLASS 2 AND 9 BUILDINGS.SAFETY GLASS TO BE USED IN THE FOLLOWING CASES: I) ALL ROOMS – WITHIN 500mm VERTICAL OF THE

II) BATHROOMS – WITHIN 300HITT VERTICAL OF THE FLOOR.

III) BATHROOMS – WITHIN 2000mm OF THE FLOOR.

III) LAUNDRY – WITHIN 1200mm VERTICAL FROM FLOOR AND/OR WITHIN 300mm HORIZONTAL FROM ALL DOORS.

IV) DOORWAY – WITHIN 300mm HORIZONTAL FROM DOORS.

N2:
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CONJUNCTION WITH ANY HOUSE ENERGY RATING (HERS) REPORT AND SHALL BE CONSTRUCTED IN ACCORDANCE WITH THE STAMPED PLANS ENDORSED BY THE ACCREDITED THERMAL
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MANUFACTURER

ALL WINDOWS AND DOORS TO BE SITE MEASURED PRIOR TO MANUFACTURER / ORDER.

ALL WINDOWS & DOORS TO BE IN ACCORDANCE WITH AS1288-2011

PROVIDE DOOR THRSHOLD TO ALL EXTERNAL

DOORS

N7: ALL DOORS & WINDOWS VIEWED FROM OUTSIDE UNLESS NOTED OTHERWISE

PROVIDE LOCKS TO ALL OPENABLE WINDOWS

AND EXTERNAL DOORS N9:

ALLOW FOR WEATHER SEALS TO ALL EDGES OF OPENING WINDOW SASHES AND DOORS.

ABBREVIATIONS

CLEAR GLAZING FIXED PANEL CG OBSCURE GLAZING

WINDOW SCHEDULE						
ID	GW01	GW02	GW03	GW04	GW05	
Location	BED 04	BED 03	POWDER	BATHROOM	BED 02	
Height	1,200	1,200	1,200	300	1,200	
Width	2,100	2,100	600	900	2,100	
Window sill height	1,200	1,200	1,200	2,100	1,200	
Window head height	2,400	2,400	2,400	2,400	2,400	
2D Symbol	2100	2100	600	900	2100	
Elevation	2100	2100	1200	2100	2100	
Orientation	SOUTH EAST					
Accesories	FLYSCREEN	FLYSCREEN	FLYSCREEN	FLYSCREEN	FLYSCREEN	
Finish	POWDERCOAT - MONUMENT					
Frame Type	ALUMINIUM	ALUMINIUM	ALUMINIUM	ALUMINIUM	ALUMINIUM	
Glazing	REFER TO ENERGY REPORT					
Operation Type	AWNING	AWNING	AWNING	AWNING	AWNING	
Vision Panel Type	CLEAR	CLEAR	OBSCURE	OBSCURE	CLEAR	
Comments						

Company Comp					
Securition BETO 02 BEAM STORE GARAGE G	WINDOW SCHEDULE				
Neight 1200	ID	GW06	GW07	GW08	GW09
widh 2,100 2700 2,700 2,700 Window sil height 1,200 1,800 2,400 3,200 Window sil height 2,400 3,200 3,200 20 Symbol 2,100 7,700 7,700 Levelion 2,100 2,700 2,700 Levelion 2,100 2,700 2,700 Levelion 2,100 2,700 2,700 Levelion NORH-WEST NORH-WEST NORH-WEST NORH-WEST NORH-WEST NORH-WEST NORH-WEST Acception NA N/A N/A Finith POWDERCOAT-MONUMENT POWDERCOAT-MONUMENT POWDERCOAT-MONUMENT Frome type ALUMINIUM ALUMINIUM ALUMINIUM Glebing SETER TO INTROT SETORI RIFER TO INTROT SETORI RIFER TO INTROT SETORI Operation type FIXED RIFER TO INTROT SETORIC RIFER TO INTROT SETORIC RIFER TO INTROT SETORIC	Location	BED 02	BOAT STORE	GARAGE	GARAGE
North West Nor	Height	1,200	600	600	600
North Heat	Width	2,100	2,700	2,700	2,700
2100 2700	Window sill height	1,200	1,800	2,600	2,600
Blevation 2100 2700 2700 2700 2700 2700 2700 2700 Orientation NORTH FAST NORTH WEST NORTH	Window head height	2,400	2,400	3,200	3,200
Elevation 2100 27700 8 2100 27700 8 27700 8 27700 8 27700 8 27700 8 27700 8 27700 8 27700 8 27700 8 27700 8 27700 8 27700 8 27700 8 27700 8 27700 8 27700 9 27700 8 2770	2D Symbol	2100	2700	 	
Accesories N/A	Elevation	0021	*	000	
Finish POWDERCOAT - MONUMENT POWDERCOAT - MO	Orientation	NORTH EAST	NORTH WEST	NORTH WEST	NORTH WEST
Frame Type ALUMINIUM ALUMINIUM ALUMINIUM ALUMINIUM ALUMINIUM ALUMINIUM Glazing REFER TO ENERGY REPORT REFER TO ENERGY REPORT REFER TO ENERGY REPORT REFER TO ENERGY REPORT Operation Type FIXED FIXED FIXED FIXED Vision Panel Type CLEAR CLEAR CLEAR	Accesories	N/A	N/A	N/A	N/A
Glazing REFER TO ENERGY REPORT PIXED FIXED FIXED FIXED FIXED CLEAR CLEAR	Finish	POWDERCOAT - MONUMENT	POWDERCOAT - MONUMENT	POWDERCOAT - MONUMENT	POWDERCOAT - MONUMENT
Operation Type FIXED FIXED FIXED Vision Panel Type CLEAR CLEAR CLEAR	Frame Type	ALUMINIUM	ALUMINIUM	ALUMINIUM	ALUMINIUM
Vision Panel Type CLEAR CLEAR CLEAR CLEAR CLEAR	Glazing	REFER TO ENERGY REPORT			
CELT III.	Operation Type	FIXED	FIXED	FIXED	FIXED
Comments	Vision Panel Type	CLEAR	CLEAR	CLEAR	CLEAR
	Comments				

NOTES ORIGINAL A3

DO NOT SCALE DRAWINGS - REFER ONLY TO WRITTEN DIMESIONS

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	J 1	1 11 3 -	,	
REV	DATE	DESCRIPTION	DRN	CHKD
-	14.05.19	CONSTRUCTION ISSUE	ALT	AR
Α	05.07.19	LIFT COORDINATION	ALT	AR
В	09.07.19	NGL COORDINATION	ALT	AR
C	23.08.19	HEIGHT + WINDOWS	ALT	AR
D	02.09.19	17 CALIMO PL	ALT	AR
Е	05.09.19	WINDOWS	ALT	AR
F	12.09.19	NEIGHBOURS CONSENT	ALT	AR
G	19.09.19	LIFT RELOCATED	ALT	AR
Н	08.10.19	LIGHT POLE	ALT	AR
	01.11.19	BUILDING ENVELOPE	ALT	AR
J	11.11.19	FLOOR SET DOWN	ALT	AR

CLIENT

BRENDAN PETER BORG

PROJECT

LOT 09 (No. 15) CALIMO PLACE INDENTED HEAD 3223

DRAWING

WINDOW SCHEDULE 1/3

Derbyshire

DRAWN	CHECKED	SCALE
ALT	AR	1:50
DATE	PROJECT No	STATUS
1.11.2019	G1811	CD
DRAWING No		REV
A22		

GLAZING, INCLUDING SAFETY GLAZING, SHALL BE INSTALLED TO A SIZE, TYPE AND THICKNESS SO AS TO COMPLY WITH:- BCA PART 3 FOR CLASS 1 AND 10 BUILDINGS WITHIN A DESIGN WIND SPEED OF NOT MORE THAN N3; AND - NCC 2019 BCA VOL 1 PART B1.4 FOR CLASS 2 AND 9 BUILDINGS.SAFETY GLASS TO BE USED IN THE FOLLOWING CASES: I) ALL ROOMS – WITHIN 500mm VERTICAL OF THE

II) BATHROOMS – WITHIN 2001MIN VERTICAL OF THE FLOOR. III) BATHROOMS – WITHIN 2000mm OF THE FLOOR. III) LAUNDRY – WITHIN 1200mm VERTICAL FROM FLOOR AND/OR WITHIN 300mm HORIZONTAL FROM ALL DOORS.

IV) DOORWAY – WITHIN 300mm HORIZONTAL FROM DOORS.

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MANUFACTURER ALL WINDOWS AND DOORS TO BE SITE MEASURED

PRIOR TO MANUFACTURER / ORDER. ALL WINDOWS & DOORS TO BE IN ACCORDANCE

WITH AS1288-2011

PROVIDE DOOR THRSHOLD TO ALL EXTERNAL DOORS

ALL DOORS & WINDOWS VIEWED FROM OUTSIDE UNLESS NOTED OTHERWISE


PROVIDE LOCKS TO ALL OPENABLE WINDOWS

AND EXTERNAL DOORS

ALLOW FOR WEATHER SEALS TO ALL EDGES OF OPENING WINDOW SASHES AND DOORS.

ABBREVIATIONS

CLEAR GLAZING FIXED PANEL OBSCURE GLAZING

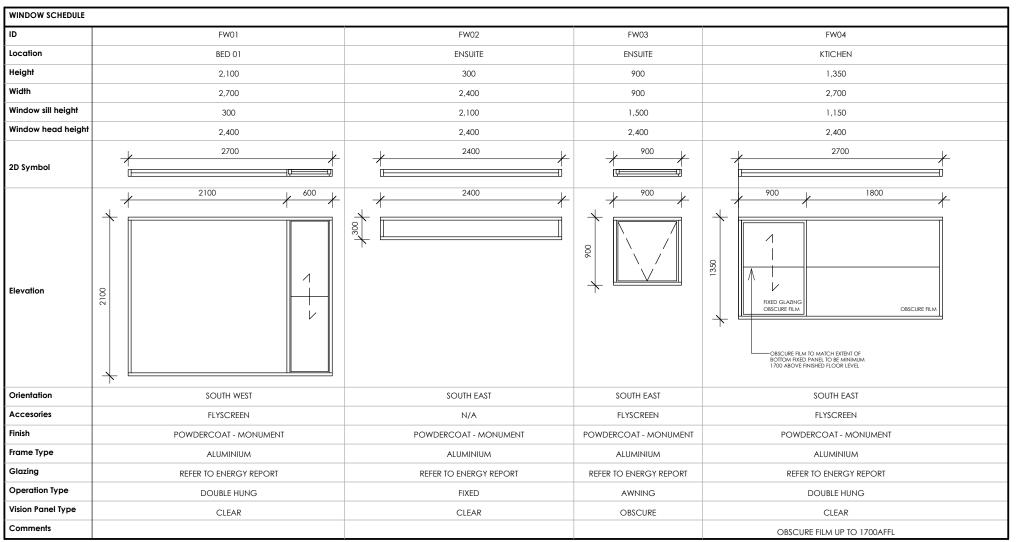

WINDOW SCHEDULE				
ID	FW05	FW08	FW09	
Location	DINING	LIVING	STUDY / STAIRS	
Height	1,500	900	900	
Width	2,700	4,500	3,600	
Window sill height	900	2,600	1,800	
Window head height	2,400	3,500	2,700	
2D Symbol	2700	4500	3600	
Elevation	2700 OBSCURE FILM OBSCURE FILM	4500	3600	
Orientation	SOUTH EAST	NORTH EAST	NORTH WEST	
Accesories	FLYSCREEN	N/A	N/A	
Finish	POWDERCOAT - MONUMENT	POWDERCOAT - MONUMENT	POWDERCOAT - MONUMENT	
Frame Type	ALUMINIUM	ALUMINIUM	ALUMINIUM	
Glazing	REFER TO ENERGY REPORT	REFER TO ENERGY REPORT	REFER TO ENERGY REPORT	
Operation Type	AWNING	FIXED	FIXED	
Vision Panel Type	CLEAR	CLEAR	CLEAR	
Comments	OBSCURE FILM UP TO 1700AFFL			

NOTES ORIGINAL A3

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REV	DATE	DESCRIPTION	DRN	CHKE
-	14.05.19	CONSTRUCTION ISSUE	ALT	AR
Α	05.07.19	LIFT COORDINATION	ALT	AR
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G	19.09.19	LIFT RELOCATED	ALT	AR
Н	08.10.19	LIGHT POLE	ALT	AR
	01.11.19	BUILDING ENVELOPE	ALT	AR
J	11.11.19	FLOOR SET DOWN	ALT	AR

CLIENT

BRENDAN PETER BORG

PROJECT

LOT 09 (No. 15) CALIMO PLACE INDENTED HEAD 3223

DRAWING

WINDOW SCHEDULE 2/3

Derbyshire

DRAWN	CHECKED	SCALE
ALT	AR	1:50
DATE	PROJECT No	STATUS
1.11.2019	G1811	CD
DRAWING No		REV
A23		

GLAZING, INCLUDING SAFETY GLAZING, SHALL BE INSTALLED TO A SIZE, TYPE AND THICKNESS SO AS TO COMPLY WITH:- BCA PART 3 FOR CLASS 1 AND

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IV) DOORWAY – WITHIN 300mm HORIZONTAL FROM DOORS.

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ALL WINDOWS & DOORS TO BE IN ACCORDANCE WITH AS1288-2011

PROVIDE DOOR THRSHOLD TO ALL EXTERNAL

DOORS N7: ALL DOORS & WINDOWS VIEWED FROM OUTSIDE

UNLESS NOTED OTHERWISE

PROVIDE LOCKS TO ALL OPENABLE WINDOWS

AND EXTERNAL DOORS

ALLOW FOR WEATHER SEALS TO ALL EDGES OF OPENING WINDOW SASHES AND DOORS.

ABBREVIATIONS

CLEAR GLAZING FIXED PANEL OBSCURE GLAZING

WINDOW SCHEDULE				
ID	FW10	FW06	FW07	
Location	BED 01	DINING	DINING	
Height	600	2,700	2,700	
Width	2,700	1,200	3,200	
Window sill height	1,800	0	0	
Window head height	2,400	2,700	2,700	
2D Symbol	2700	1200	3200	
Elevation	2700	0022	3200	
Orientation	NORTH WEST	SOUTH EAST	NORTH EAST	
Accesories	N/A	N/A	N/A	
Finish	POWDERCOAT - MONUMENT	POWDERCOAT - MONUMENT	POWDERCOAT - MONUMENT	
Frame Type	ALUMINIUM	ALUMINIUM	ALUMINIUM	
Glazing	REFER TO ENERGY REPORT	REFER TO ENERGY REPORT	REFER TO ENERGY REPORT	
Operation Type	FIXED	FIXED	FIXED	
Vision Panel Type	CLEAR	CLEAR	CLEAR	
Comments		CORNER WINDOW OBSCURE FILM TO 1700 ABOVE AFFL	CORNER WINDOW	

NOTES ORIGINAL A3

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REV	DATE	DESCRIPTION	DRN	CHKD
-	14.05.19	CONSTRUCTION ISSUE	ALT	AR
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D	02.09.19	17 CALIMO PL	ALT	AR
Е	05.09.19	WINDOWS	ALT	AR
F	12.09.19	NEIGHBOURS CONSENT	ALT	AR
G	19.09.19	LIFT RELOCATED	ALT	AR
Н	08.10.19	LIGHT POLE	ALT	AR
	01.11.19	BUILDING ENVELOPE	ALT	AR
J	11.11.19	FLOOR SET DOWN	ALT	AR

CLIENT

BRENDAN PETER BORG

PROJECT

LOT 09 (No. 15) CALIMO PLACE INDENTED HEAD 3223

DRAWING

A24

WINDOW SCHEDULE 3/3

Derbyshire

Address: 98 Pakington St, Geelong West VIC 3218 Phone: (03) 5221 8409

DRAWN CHECKED SCALE ALT AR 1:50 DATE PROJECT No STATUS 1.11.2019 CD G1811 DRAWING No REV

THE LOCATION OF SERVICES IS APPROXIMATE ONLY. BUILDER TO DETERMINE THE EXACT LOCATIONS OF SERVICES ON SITE PRIOR TO TENDERING.

DRAWINGS ARE TO BE READ IN CONJUNCTION WIITH JOINERY SCHEDULE IN SPECIFICATION CHECK & CONFIRM ALL DIMENSIONS ON SITE

PRIOR TO MANUFACTURING / CONSTRUCTION

UNLESS OTHERWISE NOTED, ALL INTERNAL CARCASSES TO BE WHITE MELAMINE

ALL WET AREAS TO COMPLY WITH AS 3740. WALL FINISHES SHALL BE IMPERVIOUS TO A HEIGHT OF 1800mm ABOVE FLOOR LEVEL TO SHOWER ENCLOSURES AND 300mm ABOVE BATHS, BASINS, SINKS AND TROUGHS IF WITHIN 75mm OF THE WALL. REFER TO CODE FOR ALL REQUIREMENTS.

N6: W.C. DOORS TO TOILET PANS LOCATED WITHIN 1.2m OF THE DOOR JAMB LIFT OFF HINGES MUST BE FITTED. OTHERWISE THE DOORS MUST SWING OUTWARDS.

SAFETY GLASS TO BE USED IN THE FOLLOWING

I) ALL ROOMS – WITHIN 500mm VERTICAL OF THE FLOOR.

II) BATHROOMS – WITHIN 2000mm OF THE FLOOR.
III) LAUNDRY – WITHIN 1200mm VERTICAL FROM FLOOR AND/OR WITHIN 300mm HORIZONTAL FROM ALL DOORS

IV) DOORWAY – WITHIN 300mm HORIZONTAL

FROM DOORS.
SHOWER SCREENS SHALL BE GRADE A SAFETY

MATERIALS & FINISHES SCHEDULE

BARESTONE CARPET CB1 CB2 CONCRETE BENCH 65MM CONCRETE BENCH 25MM COS FSS CONCRETE SLAB FRAMELESS SHOWER SCREEN KI1 LA1 I AMINTATE TYPE 1 LB1 LAMINATED BENCHTOP MA1 MDF WHITE MELAMINE PAINTED MDF MIRROR SPLASHBACK PLASTERBOARD PAINT FINISH PB PB2 WET AREA PLASTERBOARD -VILLABOARD MAXIPLY - WHITE PLY RECONSTITUTED STONE RS2 SK TF RECONSTITUTED SOTNE TIMBER SKIRTING

REFER TO DERBYSHIRE SPECIFICATION FOR COMPLETE SPECIFICATION OF MATERIALS & DETAILS OF FINISH.

TIMBER FLOORING

TIMBER

FLOOR TILE WALL TILF TILE SPLASHBACK

TILE SKIRTING

ABBREVIATIONS


ADJUSTABE SHELF BATH SPOUT BS CSD CTB DRW CAVITI SLIDING DOOR COUNTER TOP BASIN DRAWER DRYER DISHWASHER DRY DW FCL FFL FS FW GFS GPO HR HTR FINISHED CEILING LEVEL FINISHED FLOOR LEVEL FIXED SHELF FLOOR WASTE GLAZED FIXED SHELF GENERAL PURPOSE OUTLET HANGING PAIL HAND TOWEL RAIL LTR MH LAUNDRY TROUGH MI MX MIRROR MIXER TAP MW MICROWAVE NOM NOMINAL LENGHT NS OS NOOK SHELF OPEN SHELF PL RA PENDANT LIGHT RETURN AIR DUCT REF S(U) SHR REFRIGERATOR SINK UNDERMOUN SHOWER SHOWER HEAD TOWEL RAIL (TR(H) - HEATED) SHH TR TRH

TOILET ROLL HOLDER


WALL HUNG BASIN

TOILET SUITE


WALL OVEN WASHING MACHINE

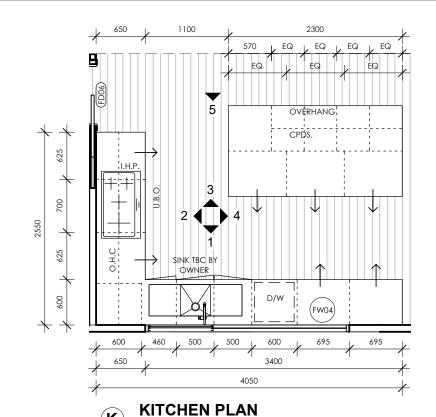



SCALE 1:50

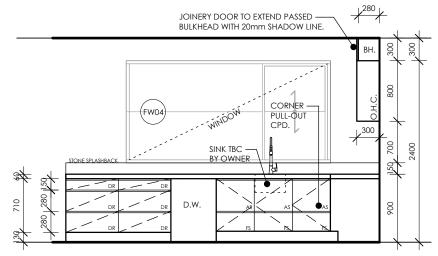


KITCHEN ELEV SCALE 1:50

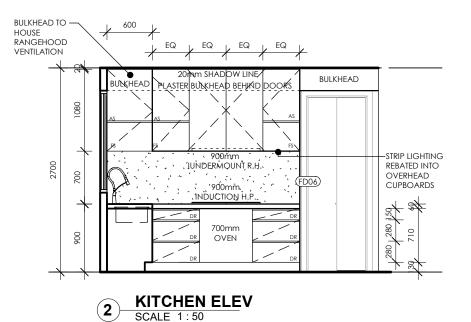

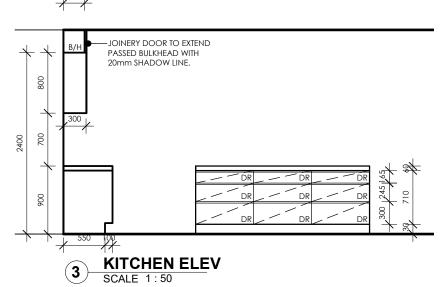

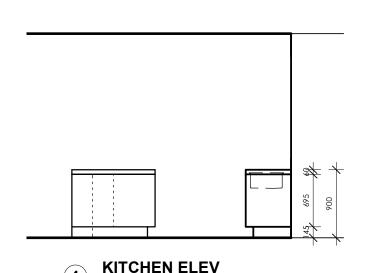

SCALE 1:50

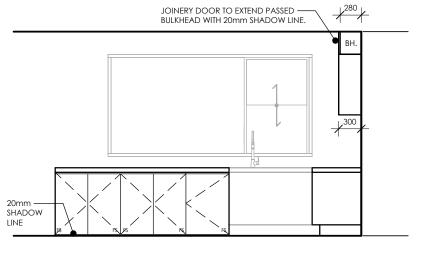

KITCHEN ELEV (5) SCALE 1:50

NOTES ORIGINAL A3

DO NOT SCALE DRAWINGS - REFER ONLY TO WRITTEN DIMESIONS

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Notify Derbyshire Homes of any discrepancies. Drawings to be read in conjuction with specifications.

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REV	DATE	DESCRIPTION	DRN	CHKD
-	14.05.19	CONSTRUCTION ISSUE	ALT	AR
Α	05.07.19	LIFT COORDINATION	ALT	AR
В	09.07.19	NGL COORDINATION	ALT	AR
C	23.08.19	HEIGHT + WINDOWS	ALT	AR
D	02.09.19	17 CALIMO PL	ALT	AR
Е	05.09.19	WINDOWS	ALT	AR
F	12.09.19	NEIGHBOURS CONSENT	ALT	AR
G	19.09.19	LIFT RELOCATED	ALT	AR
Н	08.10.19	LIGHT POLE	ALT	AR
1	01.11.19	BUILDING ENVELOPE	ALT	AR
J	11.11.19	FLOOR SET DOWN	ALT	AR

CLIENT

BRENDAN PETER BORG

PROJECT

LOT 09 (No. 15) CALIMO PLACE INDENTED HEAD 3223

DRAWING

INTERIORS KITCHEN

Derbyshire

DRAWN	CHECKED	SCALE
ALT	AR	1:50
DATE	PROJECT No	STATUS
1.11.2019	G1811	CD
DRAWING No		REV
A25		[

THE LOCATION OF SERVICES IS APPROXIMATE ONLY. BUILDER TO DETERMINE THE EXACT LOCATIONS OF SERVICES ON SITE PRIOR TO TENDERING.

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ALL WET AREAS TO COMPLY WITH AS 3740. WALL

FINISHES SHALL BE IMPERVIOUS TO A HEIGHT OF 1800mm ABOVE FLOOR LEVEL TO SHOWER ENCLOSURES AND 300mm ABOVE BATHS, BASINS, SINKS AND TROUGHS IF WITHIN 75mm OF THE WALL. REFER TO CODE FOR ALL REQUIREMENTS.

W.C. DOORS TO TOILET PANS LOCATED WITHIN 1.2m OF THE DOOR JAMB LIFT OFF HINGES MUST BE FITTED. OTHERWISE THE DOORS MUST SWING OUTWARDS.

N7: SAFETY GLASS TO BE USED IN THE FOLLOWING

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III) LAUNDRY – WITHIN 1200mm VERTICAL FROM FLOOR AND/OR WITHIN 300mm HORIZONTAL

FROM ALL DOORS.

IV) DOORWAY – WITHIN 300mm HORIZONTAL

FROM DOORS.
SHOWER SCREENS SHALL BE GRADE A SAFETY

MATERIALS & FINISHES SCHEDULE

BARESTONE CB1 CB2 CONCRETE BENCH 65MM CONCRETE BENCH 25MM CONCRETE SLAB
FRAMELESS SHOWER SCREEN COS FSS KICKET TYPE 1 LAMINTATE TYPE 1 LA1 LB1 LAMINATED BENCHTOP WHITE MELAMINE MDF PAINTED MDF MS1 MIRROR SPLASHBACK PB PB2

PLASTERBOARD PAINT FINISH WET AREA PLASTERBOARD -VILLABOARD PLY MAXIPI Y - WHITE RS1 RECONSTITUTED STONE RECONSTITUTED SOTNE TIMBER SKIRTING TIMBER FLOORING TIMBER FLOOR TILE TL2 TSP WALL TILE TILE SPLASHBACK

REFER TO DERBYSHIRE SPECIFICATION FOR COMPLETE SPECIFICATION OF MATERIALS &


ABBREVIATIONS


ADJUSTABE SHELF BATH SPOUT CAVITI SLIDING DOOR CTB DRW COUNTER TOP BASIN DRAWER DRY DW FCL FFL FS FW GFS GPO DRYER DISHWASHER FINISHED CEILING LEVEL FINISHED FLOOR LEVEL FIXED SHELF FLOOR WASTE GLAZED FIXED SHELF GENERAL PURPOSE OUTLET HANGING RAIL HAND TOWEL RAIL HR HTR LTR MH LAUNDRY TROUGH MANHOLE MI MIRROR MX MW MIXER TAP MICROWAVE NOM NOMINAL LENGHT NS OS NOOK SHELF OPEN SHELF PL RA PENDANT LIGHT RETURN AIR DUCT REF REFRIGERATOR S(U) SHR SHH TR SINK UNDERMOUNT SHOWER


SHOWER HEAD TOWEL RAIL (TR(H) - HEATED) TOILET ROLL HOLDER TOILFT SUITE

WALL HUNG BASIN WALL OVEN

WASHING MACHINE

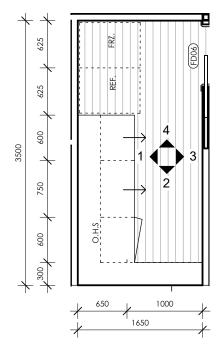

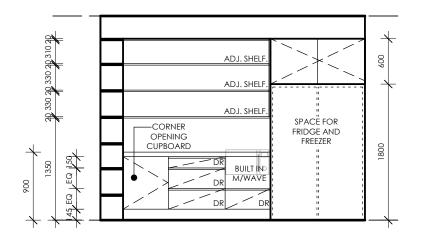


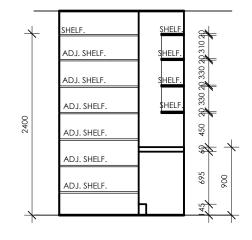



PANTRY PLAN SCALE 1:50





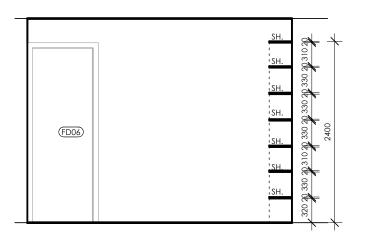

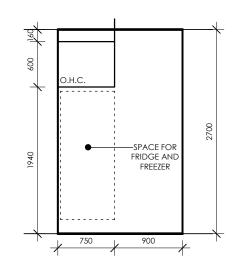


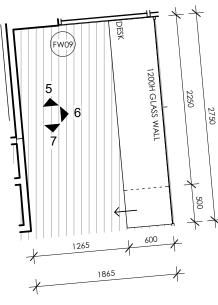


PANTRY ELEV SCALE 1:50






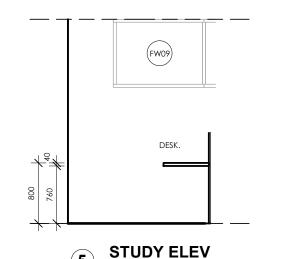

SCALE 1:50

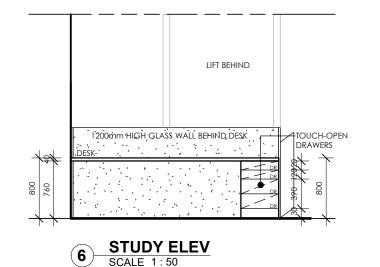

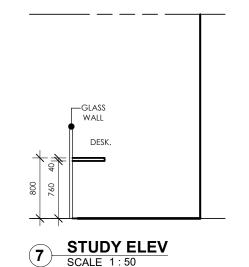

CLIENT

NOTES

REV DATE

in conjuction with specifications.

14.05.19

05.07.19

09.07.19

23.08.19

02.09.19

05.09.19

12.09.19

19.09.19

08.10.19

01.11.19

11.11.19

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Notify Derbyshire Homes of any discrepancies. Drawings to be read

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LIFT COORDINATION

NGL COORDINATION

17 CALIMO PL

LIFT RELOCATED

BUILDING ENVELOPE

FLOOR SET DOWN

WINDOWS

LIGHT POLF

CONSTRUCTION ISSUE ALT

HEIGHT + WINDOWS ALT

NEIGHBOURS CONSENT ALT

DESCRIPTION

ORIGINAL A3

DRN

ALT

ALT

ALT

ALT

ALT

ALT

BRENDAN PETER BORG

PROJECT

LOT 09 (No. 15) CALIMO PLACE INDENTED HEAD 3223

DRAWING

INTERIORS PANTRY/STUDY

Derbyshire

DRAWN	CHECKED	SCALE
ALT	AR	1:50
DATE	PROJECT No	STATUS
1.11.2019	G1811	CD
DRAWING No		REV
A26		

THE LOCATION OF SERVICES IS APPROXIMATE ONLY. BUILDER TO DETERMINE THE EXACT LOCATIONS OF SERVICES ON SITE PRIOR TO TENDERING.

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ALL WET AREAS TO COMPLY WITH AS 3740. WALL FINISHES SHALL BE IMPERVIOUS TO A HEIGHT OF 1800mm ABOVE FLOOR LEVEL TO SHOWER ENCLOSURES AND 300mm ABOVE BATHS, BASINS, SINKS AND TROUGHS IF WITHIN 75mm OF THE

N6: W.C. DOORS TO TOILET PANS LOCATED WITHIN 1.2m OF THE DOOR JAMB LIFT OFF HINGES MUST

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IV) DOORWAY – WITHIN 300mm HORIZONTAL FROM DOORS.
SHOWER SCREENS SHALL BE GRADE A SAFETY

MATERIALS & FINISHES SCHEDULE

BARESTONE CARPET CB1 CB2 CONCRETE BENCH 65MM CONCRETE BENCH 25MM COS FSS CONCRETE SLAB FRAMELESS SHOWER SCREEN I AMINTATE TYPE 1 IA1 LB1 LAMINATED BENCHTOF MA1 WHITE MELAMINE MDF PAINTED MDF MIRROR SPLASHBACK PB PB2 PLASTERBOARD PAINT FINISH WET AREA PLASTERBOARD -VILLABOARD MAXIPLY - WHITE PLY RECONSTITUTED STONE RS2 SK TF RECONSTITUTED SOTNE TIMBER SKIRTING TIMBER FLOORING TIMBER FLOOR TILE TL2 TSP WALL TILF TILE SPLASHBACK TILE SKIRTING


REFER TO DERBYSHIRE SPECIFICATION FOR COMPLETE SPECIFICATION OF MATERIALS & DETAILS OF FINISH.

ABBREVIATIONS ADJUSTABE SHELF BATH SPOUT CAVITI SLIDING DOOR CTB DRW COUNTER TOP BASIN DRAWER DRY DRYER DW DISHWASHER FCL FFL FS FW GFS FINISHED CEILING LEVEL FINISHED FLOOR LEVEL FIXED SHELF FLOOR WASTE GLAZED FIXED SHELF GENERAL PURPOSE OUTLET HR HTR HANGING RAIL HAND TOWEL RAIL LTR MH LAUNDRY TROUGH MANHOLE MI MX MIRROR MIXER TAP MW MICROWAVE NOM NOMINAL LENGHT NS OS NOOK SHELF OPEN SHELF PL RA PENDANT LIGHT RETURN AIR DUCT REF S(U) SHR REFRIGERATOR SINK UNDERMOUN SHOWER SHOWER HEAD SHH TR TOWEL RAIL (TR(H) - HEATED) TOILET ROLL HOLDER TOILET SUITE

WALL HUNG BASIN

WASHING MACHINE


WALL OVEN

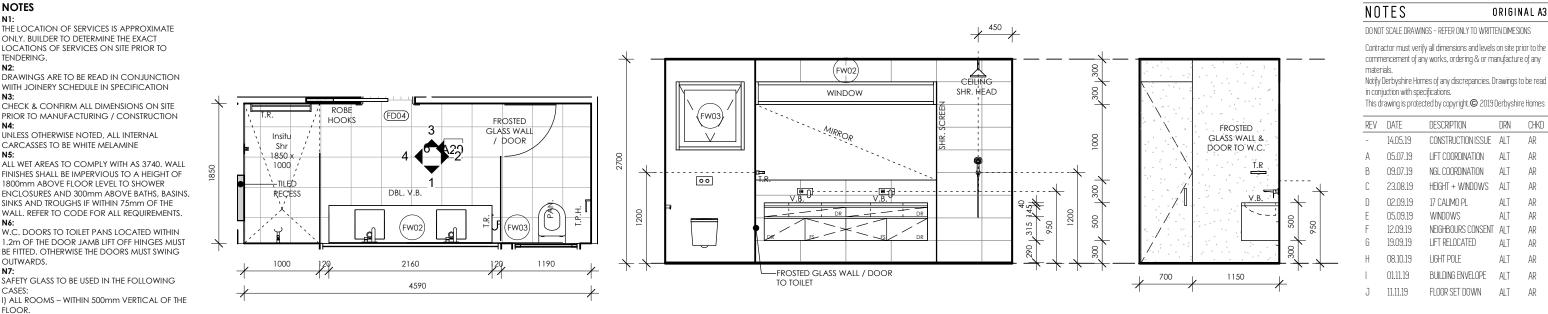

ENSUITE PLAN SCALE 1:50 SCALE 1:50

ENSUITE ELEV ENSUITE ELEV

FW01

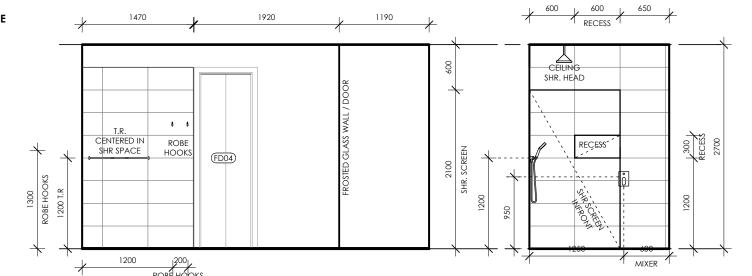

(5


SCALE 1:50

ENSUITE ELEV SCALE 1:50

ENSUITE ELEV (4 SCALE 1:50


BED 01 TV PLAN SCALE 1:50


(FD03)

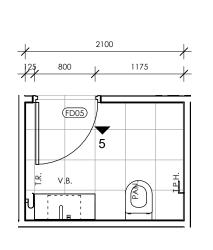

WC PLAN

SCALE 1:50

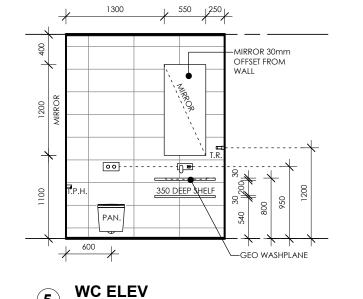

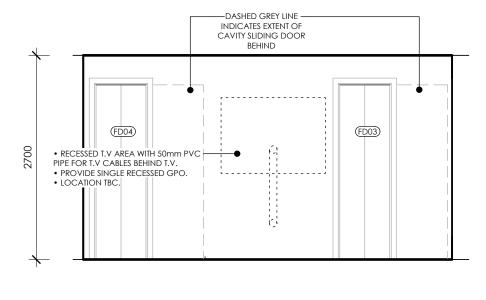

6

RECESSED

TELEVI\$ION

(FD04)

TV ELEV **(6**) SCALE 1:50 02.09.19 17 CALIMO PL WINDOWS ALT

HEIGHT + WINDOWS ALT

ORIGINAL A3

DRN

ALT

ALT

ALT

05.09.19 12.09.19 NEIGHBOURS CONSENT ALT 19.09.19 LIFT RELOCATED NR 1N 19 LIGHT POLF

01.11.19 BUILDING ENVELOPE ALT 11.11.19 FLOOR SET DOWN ALT

DESCRIPTION

CONSTRUCTION ISSUE

LIFT COORDINATION

NGL COORDINATION

14.05.19

05.07.19

09.07.19

23.08.19

CLIENT

BRENDAN PETER BORG

PROJECT

LOT 09 (No. 15) CALIMO PLACE INDENTED HEAD 3223

DRAWING

INTERIORS ENS/WC/TV

Derbyshire

DRAWN	CHECKED	SCALE
ALT	AR	1:50
DATE	PROJECT No	STATUS
1.11.2019	G1811	CD
DRAWING No		REV
A27		

THE LOCATION OF SERVICES IS APPROXIMATE ONLY. BUILDER TO DETERMINE THE EXACT LOCATIONS OF SERVICES ON SITE PRIOR TO TENDERING.

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IV) DOORWAY – WITHIN 300mm HORIZONTAL FROM DOORS.
SHOWER SCREENS SHALL BE GRADE A SAFETY

MATERIALS & FINISHES SCHEDULE

BARESTONE CARPET CB1 CB2 CONCRETE BENCH 65MM CONCRETE BENCH 25MM COS FSS CONCRETE SLAB FRAMELESS SHOWER SCREEN LA1 I AMINTATE TYPE 1 LB1 LAMINATED BENCHTOF MA1 MDF WHITE MELAMINE PAINTED MDF MIRROR SPLASHBACK PB PB2 PLASTERBOARD PAINT FINISH WET AREA PLASTERBOARD -VILLABOARD MAXIPLY - WHITE PLY RECONSTITUTED STONE RS2 SK TF RECONSTITUTED SOTNE TIMBER SKIRTING TIMBER FLOORING TIMBER FLOOR TILE TL2 TSP WALL TILF TILE SPLASHBACK

REFER TO DERBYSHIRE SPECIFICATION FOR COMPLETE SPECIFICATION OF MATERIALS & DETAILS OF FINISH.


TILE SKIRTING


ABBREVIATIONS

ADJUSTABE SHELF BATH SPOUT BS CSD CTB DRW CAVITI SLIDING DOOR COUNTER TOP BASIN DRAWER DRY DRYFR DW DISHWASHER FCL FFL FS FW GFS GPO FINISHED CEILING LEVEL FINISHED FLOOR LEVEL FIXED SHELF FLOOR WASTE GLAZED FIXED SHELF GENERAL PURPOSE OUTLET HR HTR HANGING RAII HAND TOWEL RAIL LTR MH LAUNDRY TROUGH MANHOLE MI MX MIRROR MIXER TAP MW MICROWAVE NOM NOMINAL LENGHT NS OS NOOK SHFLE OPEN SHELF PL RA PENDANT LIGHT RETURN AIR DUCT REFRIGERATOR REF S(U) SHR SHH TR TRH SINK UNDERMOUN SHOWER SHOWER HEAD TOWEL RAIL (TR(H) - HEATED) TOILET ROLL HOLDER TOILET SUITE WALL HUNG BASIN

WALL OVEN

WASHING MACHINE

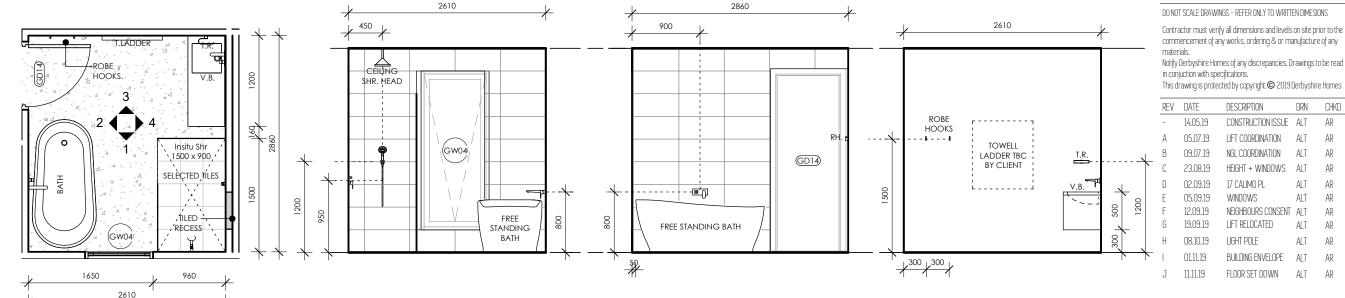

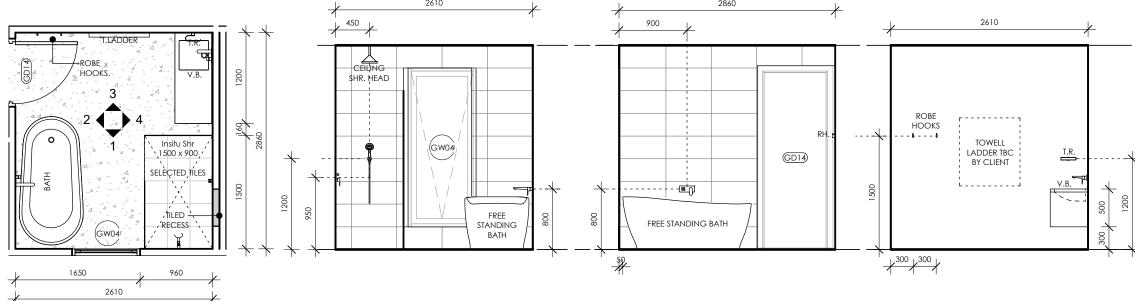

BATHROOM ELEV

SCALE 1:50

21 🖣

4GD13

(GW03)

1100

1600

BATHROOM ELEV

20mm SHADOW LINE CELLING SHR. HEAD SÀR REÇESS --950 315 # 600 + 300 + RECESS 600 1500

BATHROOM PLAN


SCALE 1:50

BATHROOM ELEV POWDER ROOM PLAN P SCALE 1:50

BATHROOM ELEV

27


SCALE 1:50

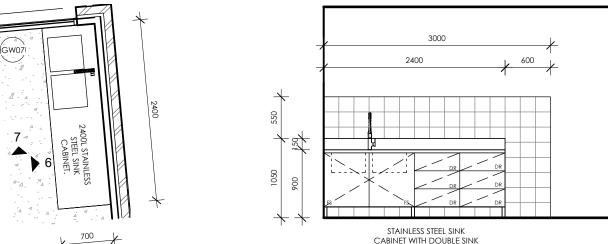


BOAT STATION PLAN SCALE 1:50

T-P H

BOAT STATION ELEV

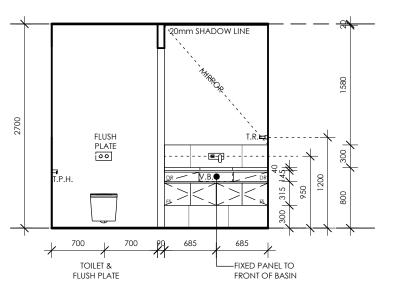

PWD ELEV SCALE 1:50

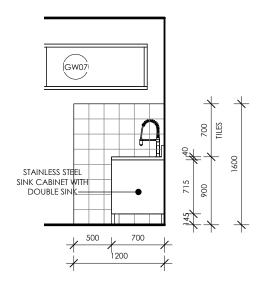

BOAT STATION ELEV

CLIENT

NOTES

14.05.19

05.07.19

09.07.19

23.08.19

02.09.19

05.09.19

12.09.19

19.09.19

NR 1N 19

01.11.19

11.11.19

ORIGINAL A3

DRN

ALT

DESCRIPTION

CONSTRUCTION ISSUE

NGL COORDINATION

17 CALIMO PL

WINDOWS

LIGHT POLF

BUILDING ENVELOPE

FLOOR SET DOWN

HEIGHT + WINDOWS ALT

NEIGHBOURS CONSENT ALT

BRENDAN PETER BORG

PROJECT

LOT 09 (No. 15) CALIMO PLACE INDENTED HEAD 3223

DRAWING

INTERIORS BATH/PWD/BOAT

Derbyshire

RAWN	CHECKED	SCALE
LT	AR	1:50
ATE	PROJECT No	STATUS
.11.2019	G1811	CD
RAWING No		REV
.28		

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IV) DOORWAY – WITHIN 300mm HORIZONTAL FROM DOORS.

SHOWER SCREENS SHALL BE GRADE A SAFETY

MATERIALS & FINISHES SCHEDULE

HANG.

SW ON)

(FD03)

WIR ELEV

SCALE 1:50

60 450

BED 04 ROBE PLAN

SCALE 1:50

NERY / SHELVING B (REFER TO W.I.R. S INTERNAL ELEVATIC


BARESTONE CARPET CB1 CB2 CONCRETE BENCH 65MM CONCRETE BENCH 25MM COS FSS CONCRETE SLAB FRAMELESS SHOWER SCREEN LA1 I AMINTATE TYPE 1 LB1 LAMINATED BENCHTOP MA1 WHITE MELAMINE MDF PAINTED MDF MIRROR SPLASHBACK PB PB2 PLASTERBOARD PAINT FINISH WET AREA PLASTERBOARD -VILLABOARD PLY MAXIPLY - WHITE RECONSTITUTED STONE RS2 SK TF RECONSTITUTED SOTNE TIMBER SKIRTING TIMBER FLOORING TIMBER FLOOR TILE TL2 TSP WALL TILF TILE SPLASHBACK TILE SKIRTING

REFER TO DERBYSHIRE SPECIFICATION FOR COMPLETE SPECIFICATION OF MATERIALS & DETAILS OF FINISH.

ABBREVIATIONS

ADJUSTABE SHELF BATH SPOUT CAVITI SLIDING DOOR CTB COUNTER TOP BASIN DRW DRAWER DRYER DISHWASHER DRY DW FCL FFL FS FW GFS FINISHED CEILING LEVEL FINISHED FLOOR LEVEL FIXED SHELF FLOOR WASTE GLAZED FIXED SHELF GENERAL PURPOSE OUTLET HR HTR HANGING RAIL HAND TOWEL RAIL LTR MH LAUNDRY TROUGH MANHOLE MI MX MIRROR MIXER TAP MW MICROWAVE NOM NOMINAL LENGHT NS OS NOOK SHELF OPEN SHELF PL RA PENDANT LIGHT RETURN AIR DUCT REF S(U) SHR REFRIGERATOR SINK UNDERMOUN SHOWER SHOWER HEAD SHH TR TRH TOWEL RAIL (TR(H) - HEATED) TOILET ROLL HOLDER TOILET SUITE WALL HUNG BASIN WO WM WALL OVEN

WASHING MACHINE

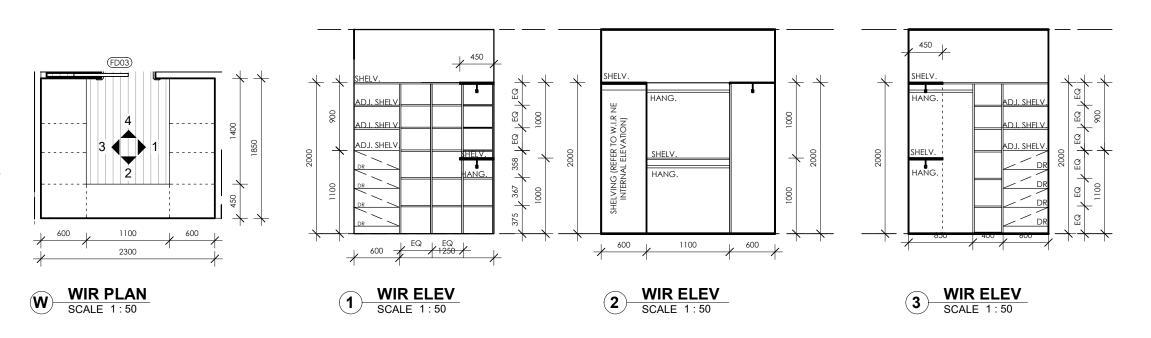

SLIDING ROBE DOORS TO FRONT

BED 02 ROBE ELEV

SCALE 1:50

HANG


1360

5

450 60


SCALE 1:50

BED 02 ROBE PLAN

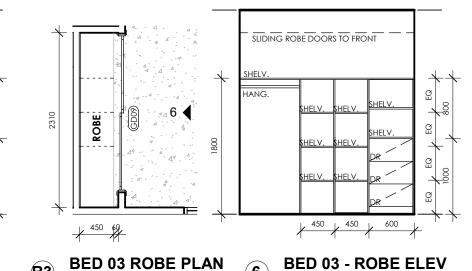

SCALE 1:50

SCALE 1:50

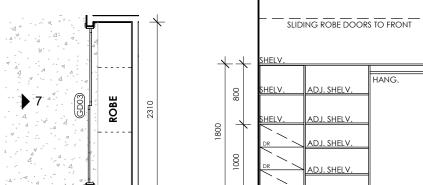


JINERY UNIT / SHELV (REFER TO W.I.R. N INTERNAL ELEVATIO



855

855


600

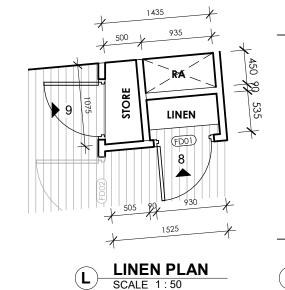

Q

Q

SHELV

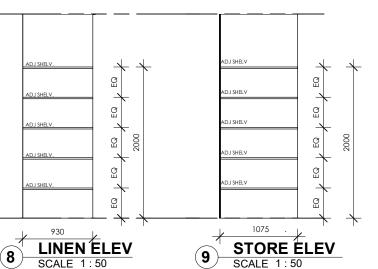

CLIENT

NOTES

REV DATE

in conjuction with specifications.

14.05.19

05.07.19

09.07.19

23.08.19

02.09.19

05.09.19

12.09.19

19.09.19

08.10.19

01.11.19

11.11.19

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Notify Derbyshire Homes of any discrepancies. Drawings to be read

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CONSTRUCTION ISSUE

LIFT COORDINATION

NGL COORDINATION

17 CALIMO PL

WINDOWS

LIGHT POLF

BUILDING ENVELOPE

FLOOR SET DOWN

HEIGHT + WINDOWS ALT

NEIGHBOURS CONSENT ALT

ORIGINAL A3

DRN

ALT

ALT

ALT

ALT

ALT

ALT

BRENDAN PETER BORG

PROJECT

LOT 09 (No. 15) CALIMO PLACE INDENTED HEAD 3223

DRAWING

INTERIORS ROBES/LINEN

Derbyshire

IRAWN	CHECKED	SCALE
ALT .	AR	1:50
IATE	PROJECT No	STATUS
.11.2019	G1811	CD
RAWING No		REV
129		

THE LOCATION OF SERVICES IS APPROXIMATE ONLY. BUILDER TO DETERMINE THE EXACT LOCATIONS OF SERVICES ON SITE PRIOR TO TENDERING.

DRAWINGS ARE TO BE READ IN CONJUNCTION WIITH JOINERY SCHEDULE IN SPECIFICATION CHECK & CONFIRM ALL DIMENSIONS ON SITE PRIOR TO MANUFACTURING / CONSTRUCTION

UNLESS OTHERWISE NOTED, ALL INTERNAL

CARCASSES TO BE WHITE MELAMINE

ALL WET AREAS TO COMPLY WITH AS 3740. WALL FINISHES SHALL BE IMPERVIOUS TO A HEIGHT OF 1800mm ABOVE FLOOR LEVEL TO SHOWER ENCLOSURES AND 300mm ABOVE BATHS, BASINS, SINKS AND TROUGHS IF WITHIN 75mm OF THE WALL. REFER TO CODE FOR ALL REQUIREMENTS.

N6: W.C. DOORS TO TOILET PANS LOCATED WITHIN 1.2m OF THE DOOR JAMB LIFT OFF HINGES MUST BE FITTED. OTHERWISE THE DOORS MUST SWING

OUTWARDS. SAFETY GLASS TO BE USED IN THE FOLLOWING

I) ALL ROOMS – WITHIN 500mm VERTICAL OF THE

FLOOR. II) BATHROOMS – WITHIN 2000mm OF THE FLOOR.
III) LAUNDRY – WITHIN 1200mm VERTICAL FROM FLOOR AND/OR WITHIN 300mm HORIZONTAL FROM ALL DOORS

IV) DOORWAY – WITHIN 300mm HORIZONTAL FROM DOORS.
SHOWER SCREENS SHALL BE GRADE A SAFETY

MATERIALS & FINISHES SCHEDULE

BARESTONE CARPET CONCRETE BENCH 65MM CB1 CB2 CONCRETE BENCH 25MM COS FSS CONCRETE SLAB FRAMELESS SHOWER SCREEN LA1 I AMINTATE TYPE 1 LB1 LAMINATED BENCHTOF MA1 MDF WHITE MELAMINE PAINTED MDF MIRROR SPLASHBACK PB PB2 PLASTERBOARD PAINT FINISH WET AREA PLASTERBOARD -VILLABOARD MAXIPLY - WHITE PLY RECONSTITUTED STONE RS2 SK TF RECONSTITUTED SOTNE TIMBER SKIRTING TIMBER FLOORING TIMBER FLOOR TILE

REFER TO DERBYSHIRE SPECIFICATION FOR COMPLETE SPECIFICATION OF MATERIALS & DETAILS OF FINISH.

WALL TILF TILE SPLASHBACK TILE SKIRTING

ABBREVIATIONS


TL2 TSP

ADJUSTABE SHELF BATH SPOUT BS CSD CTB DRW CAVITI SLIDING DOOR COUNTER TOP BASIN DRAWER DRY DRYER DW DISHWASHER FCL FFL FS FW GFS GPO FINISHED CEILING LEVEL FINISHED FLOOR LEVEL FIXED SHELF FLOOR WASTE GLAZED FIXED SHELF GENERAL PURPOSE OUTLET HR HTR HANGING RAIL HAND TOWEL RAIL LTR MH LAUNDRY TROUGH MANHOLE MI MX MIRROR MIXER TAP MW MICROWAVE NOM NOMINAL LENGHT NS OS NOOK SHELF OPEN SHELF PL RA PENDANT LIGHT RETURN AIR DUCT REF S(U) SHR REFRIGERATOR SINK UNDERMOUN SHOWER SHH TR TRH SHOWER HEAD TOWEL RAIL (TR(H) - HEATED)

TOILET ROLL HOLDER TOILET SUITE WALL HUNG BASIN

WASHING MACHINE

WALL OVEN

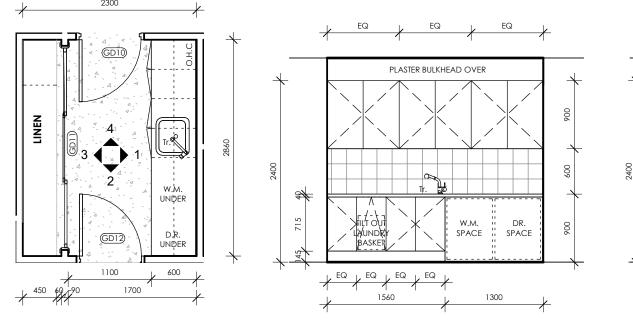

LAUNDRY PLAN

ROBE SLIDING DOORS INFRONT

2260

LAUNDRY ELEV

WET ROOM ELEV

SCALE 1:50

SCALE 1:50

600

SCALE 1:50

 Image: Control of the control of the

g


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 Image: Control of the control of the

(3

(GD12) 500 100

LAUNDRY ELEV SCALE 1:50



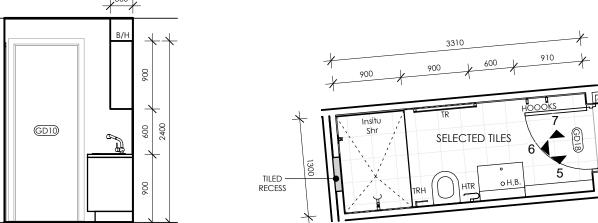

100 500




WET ROOM ELEV

SCALE 1:50

1400

LAUNDRY ELEV

SCALE 1:50

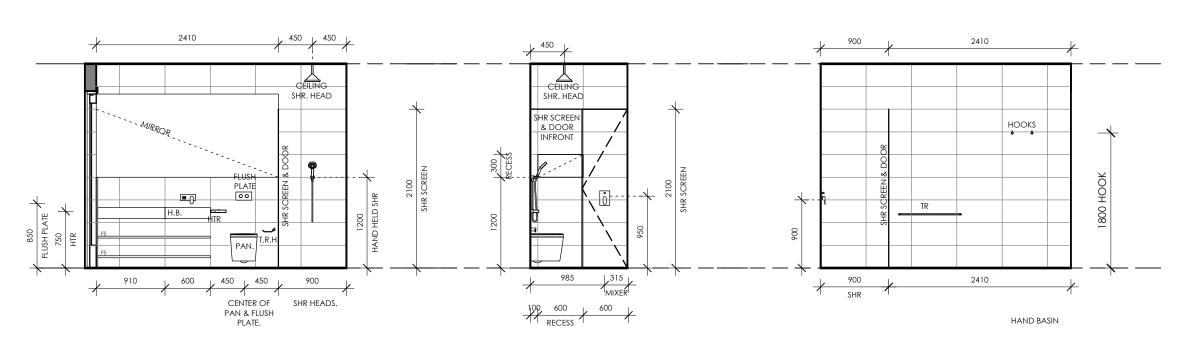

WET ROOM ELEV

SCALE 1:50

DO NOT SCALE DRAWINGS - REFER ONLY TO WRITTEN DIMESIONS Contractor must verify all dimensions and levels on site prior to the

ORIGINAL A3

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NOTES

REV	DATE	DESCRIPTION	DRN	CHKD
-	14.05.19	CONSTRUCTION ISSUE	ALT	AR
Α	05.07.19	LIFT COORDINATION	ALT	AR
В	09.07.19	NGL COORDINATION	ALT	AR
\mathbb{C}	23.08.19	HEIGHT + WINDOWS	ALT	AR
D	02.09.19	17 CALIMO PL	ALT	AR
E	05.09.19	WINDOWS	ALT	AR
F	12.09.19	NEIGHBOURS CONSENT	ALT	AR
G	19.09.19	LIFT RELOCATED	ALT	AR
Н	08.10.19	LIGHT POLE	ALT	AR
	01.11.19	BUILDING ENVELOPE	ALT	AR
J	11.11.19	FLOOR SET DOWN	ALT	AR

CLIENT

BRENDAN PETER BORG

PROJECT

LOT 09 (No. 15) CALIMO PLACE INDENTED HEAD 3223

DRAWING

INTERIORS LAUNDRY/WET ROOM

Derbyshire

DRAWN	CHECKED	SCALE
ALT	AR	1:50
DATE	PROJECT No	STATUS
1.11.2019	G1811	CD
DRAWING No		REV
A30		

THE LOCATION OF SERVICES IS APPROXIMATE ONLY. BUILDER TO DETERMINE THE EXACT LOCATIONS OF SERVICES ON SITE PRIOR TO TENDERING.

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PRIOR TO MANUFACTURING / CONSTRUCTION

UNLESS OTHERWISE NOTED, ALL INTERNAL CARCASSES TO BE WHITE MELAMINE

ALL WET AREAS TO COMPLY WITH AS 3740. WALL FINISHES SHALL BE IMPERVIOUS TO A HEIGHT OF 1800mm ABOVE FLOOR LEVEL TO SHOWER ENCLOSURES AND 300mm ABOVE BATHS, BASINS, SINKS AND TROUGHS IF WITHIN 75mm OF THE WALL. REFER TO CODE FOR ALL REQUIREMENTS.

N6: W.C. DOORS TO TOILET PANS LOCATED WITHIN 1.2m OF THE DOOR JAMB LIFT OFF HINGES MUST BE FITTED. OTHERWISE THE DOORS MUST SWING

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IV) DOORWAY – WITHIN 300mm HORIZONTAL FROM DOORS.
SHOWER SCREENS SHALL BE GRADE A SAFETY

MATERIALS & FINISHES SCHEDULE

BARESTONE CARPET CONCRETE BENCH 65MM CB1 CB2 CONCRETE BENCH 25MM COS FSS CONCRETE SLAB FRAMELESS SHOWER SCREEN LA1 I AMINTATE TYPE 1 LB1 LAMINATED BENCHTOF MA1 MDF WHITE MELAMINE PAINTED MDF MIRROR SPLASHBACK PB PB2 PLASTERBOARD PAINT FINISH WET AREA PLASTERBOARD -VILLABOARD PLY MAXIPLY - WHITE RECONSTITUTED STONE RS2 SK TF RECONSTITUTED SOTNE

TIMBER SKIRTING

TIMBER FLOORING TIMBER FLOOR TILE

TILE SPLASHBACK

TILE SKIRTING REFER TO DERBYSHIRE SPECIFICATION FOR COMPLETE SPECIFICATION OF MATERIALS & DETAILS OF FINISH.

WALL TILF

ABBREVIATIONS

TL2 TSP

ADJUSTABE SHELF BATH SPOUT BS CSD CTB DRW CAVITI SLIDING DOOR COUNTER TOP BASIN DRAWER DRY DW DRYER DISHWASHER FCL FFL FS FW GFS GPO FINISHED CEILING LEVEL FINISHED FLOOR LEVEL FIXED SHELF FLOOR WASTE GLAZED FIXED SHELF GENERAL PURPOSE OUTLET HR HTR HANGING RAIL HAND TOWEL RAIL LTR MH LAUNDRY TROUGH MANHOLE MI MX MIRROR MIXER TAP MW MICROWAVE NOM NOMINAL LENGHT NS OS NOOK SHELF OPEN SHELF PL RA PENDANT LIGHT RETURN AIR DUCT REF S(U) SHR REFRIGERATOR SINK UNDERMOUN

SHOWER

SHOWER HEAD TOWEL RAIL (TR(H) - HEATED)


TOILET ROLL HOLDER TOILET SUITE

WALL HUNG BASIN

WASHING MACHINE

WALL OVEN

SHH TR TRH

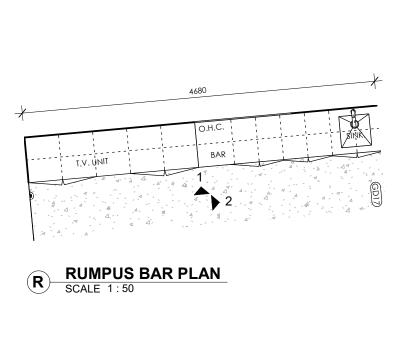


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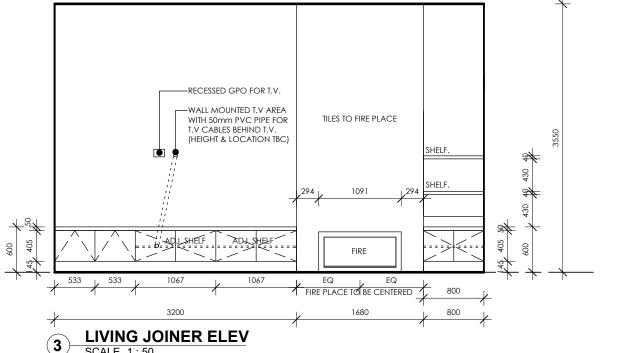
LIVING JOINERY PLAN


BBQ PLAN


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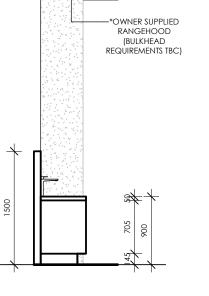






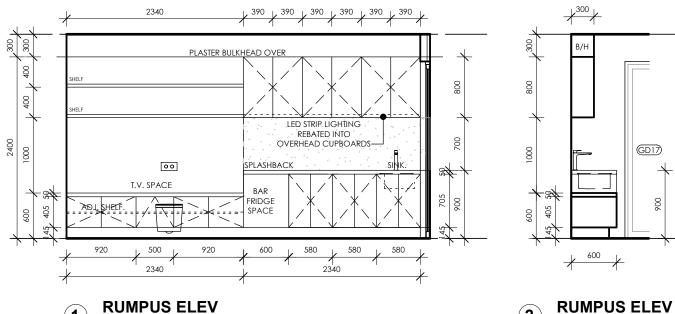

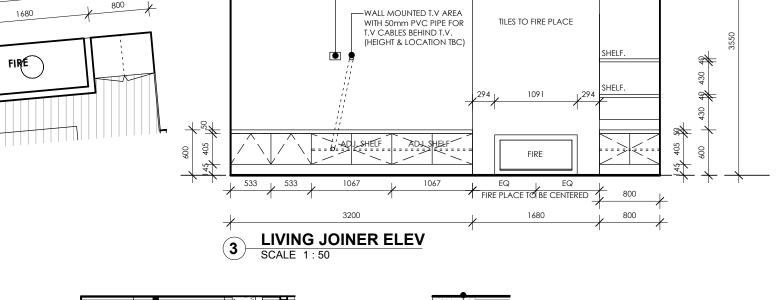SCALE 1:50

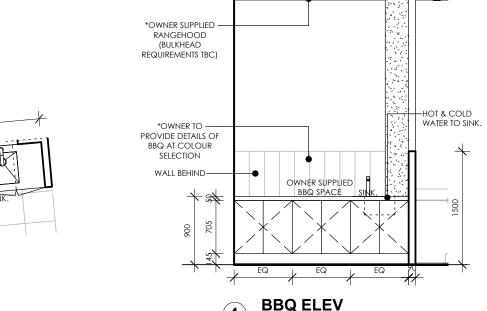

BBQ ELEV

SCALE 1:50

(5)

INTERIORS LIVING/RUMPUS/BBQ

Derbyshire

Address: 98 Pakington St, Geelong West VIC 3218 Phone: (03) 5221 8409

NOTES

REV DATE

(GD17)

(2)

SCALE 1:50

in conjuction with specifications

14.05.19

05.07.19

09.07.19

23.08.19

02.09.19

05.09.19

12.09.19

19.09.19

08.10.19

01.11.19

11.11.19

CLIENT

PROJECT

DRAWING

BRENDAN PETER BORG

INDENTED HEAD 3223

LOT 09 (No. 15) CALIMO PLACE

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CONSTRUCTION ISSUE

LIFT COORDINATION

NGL COORDINATION

17 CALIMO PL

LIFT RELOCATED

BUILDING ENVELOPE

FLOOR SET DOWN

WINDOWS

LIGHT POLF

HEIGHT + WINDOWS ALT

NEIGHBOURS CONSENT ALT

DESCRIPTION

ORIGINAL A3

DRN

ALT

ALT

ALT


ALT

ALT

ALT

ALT

DRAWN	CHECKED	SCALE
ALT	AR	1:50
DATE	PROJECT No	STATUS
1.11.2019	G1811	CD
DRAWING No		REV
A31		1

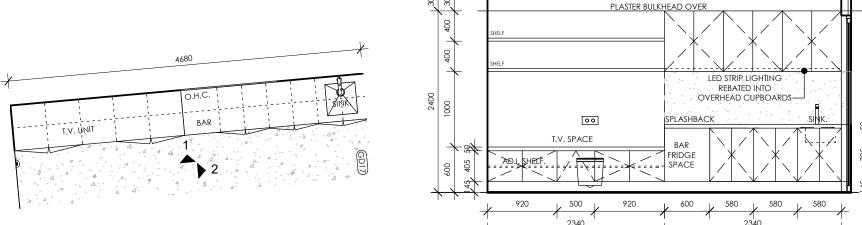

SCALE 1:50


STEP SIZES (OTHER THAN FOR SPIRAL STAIRS) TO BE: -RISERS (R) 190MM MAXIMUM AND 115MM MINIMUM -GOING (G) 355 MAXIMUM AND 240 MINIMUM - 2R + 1G = 700MM MAXIMUM AND 550MM MINIMUM - WITH LESS THAN 125MM GAP BETWEEN OPEN TREADS.

ALL TREADS, LANDINGS AND THE LIKE TO HAVE NON-SLIP FINISH OR SUITABLE NON-SKID STRIP NEAR EDGE OF NOSING.

PROVIDE BALUSTRADES WHERE CHANGE IN LEVEL EXCEEDS 1000MM ABOVE THE SURFACE BENEATH LANDINGS, RAMPS AND/OR TREADS. BALUSTRADES

(OTHER THAN TENSIONED WIRE BALUSTRADES) TO BE:-1000MM MIN. ABOVE FINISHED SURFACE LEVEL OF BALCONIES, LANDINGS OR THE LIKE, AND - 865MM MIN, ABOVE FINISHED SURFACE LELEL OF STAIR NOSING OR RAMP, AND -VERTICAL WITH LESS THAN 125MM GAP BETWEEN, AND - ANY HORIZONTAL ELEMENT WITHIN THE BALUSTRADE BETWEEN 150MM AND 760MM ABOVE THE FLOOR MUST NOT FACILITATE CLIMBING WHERE CHANGES IN LEVEL EXCEEDS 4000MM ABOVE THE SURFACE BENEATH LANDINGS, RAMPS AND/OR TREADS. WIRE BALUSTRADE CONSTRUCTION TO COMPLY WITH BCA PART 3.9,2.3 FOR CLASS 1 AND 10 BUILDINGS AND NCC 2019 BCA VOLUME 1 PART D2.16 FOR OTHER CLASSES OF BUILDINGS. TOP OF HAND RAILS TO BE MINIMUM $865\mathrm{MM}$ VERTICALLY ABOVE STAIR NOSING AND FLOOR

CHECK & CONFIRM ALL DIMENSIONS ON SITE PRIOR TO MANUFACTURING / CONSTRUCTION

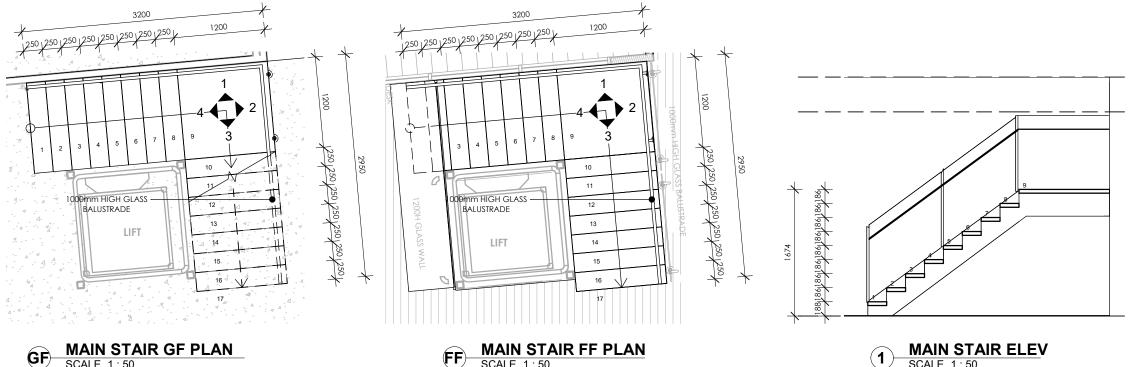

REV DATE 14.05.19 05.07.19 09.07.19 23.08.19 02.09.19 05.09.19 12.09.19 19.09.19 08.10.19

NOTES

in conjuction with specifications.

01.11.19

11.11.19

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LIFT COORDINATION

NGL COORDINATION

17 CALIMO PL

LIFT RELOCATED

BUILDING ENVELOPE

FLOOR SET DOWN

WINDOWS

LIGHT POLE

CONSTRUCTION ISSUE ALT

HEIGHT + WINDOWS ALT

NEIGHBOURS CONSENT ALT

ORIGINAL A3

DRN

ALT

ALT

ALT

ALT

ALT

SCALE 1:50

MATERIALS & FINISHES SCHEDULE

REFER TO DERBYSHIRE SPECIFICATION FOR COMPLETE SPECIFICATION OF MATERIALS & DETAILS OF FINISH.


ABBREVIATIONS

FRAMELESS GLASS BALUSTRADE

DOOR No. (XX)

XX WINDOW No.

 $\langle XX \rangle$ MATERIAL

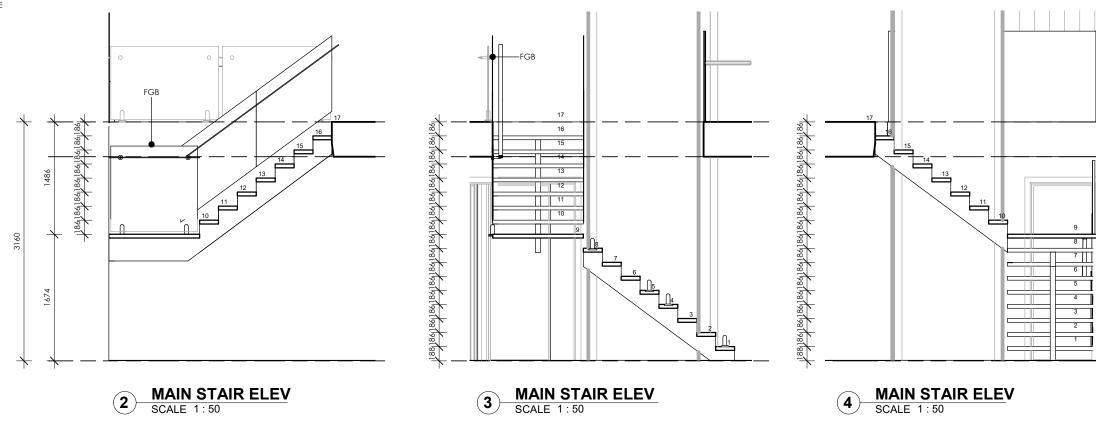

CLIENT

BRENDAN PETER BORG

PROJECT

LOT 09 (No. 15) CALIMO PLACE INDENTED HEAD 3223

STAIR DETAILS - MAIN

Derbyshire

DRAWN	CHECKED	SCALE
ALT	AR	1:50
DATE	PROJECT No	STATUS
1.11.2019	G1811	CD
DRAWING No		REV
A32		

STEP SIZES (OTHER THAN FOR SPIRAL STAIRS) TO BE: -RISERS (R) 190MM MAXIMUM AND 115MM MINIMUM -GOING (G) 355 MAXIMUM AND 240 MINIMUM - 2R + 1G = 700MM MAXIMUM AND 550MM MINIMUM - WITH LESS THAN 125MM GAP BETWEEN OPEN TREADS.

N2

ALL TREADS, LANDINGS AND THE LIKE TO HAVE NON-SLIP FINISH OR SUITABLE NON-SKID STRIP NEAR EDGE OF NOSING.

N3:

PROVIDE BALUSTRADES WHERE CHANGE IN LEVEL EXCEEDS 1000MM ABOVE THE SURFACE BENEATH LANDINGS, RAMPS AND/OR TREADS. BALUSTRADES


(OTHER THAN TENSIONED WIRE BALUSTRADES) TO BE:-1000MM MIN. ABOVE FINISHED SURFACE LEVEL OF BALCONIES, LANDINGS OR THE LIKE, AND - 865MM MIN, ABOVE FINISHED SURFACE LELEL OF STAIR NOSING OR RAMP, AND - VERTICAL WITH LESS THAN 125MM GAP BETWEEN, AND - ANY HORIZONTAL ELEMENT WITHIN THE BALUSTRADE BETWEEN 150MM AND 760MM ABOVE THE FLOOR MUST NOT FACILITATE CLIMBING WHERE CHANGES IN LEVEL EXCEEDS 4000MM ABOVE THE SURFACE BENEATH LANDINGS, RAMPS AND/OR TREADS, WIRE BALUSTRADE CONSTRUCTION TO COMPLY WITH BCA PART 3.9,2.3 FOR CLASS 1 AND 10 BUILDINGS AND NCC 2019 BCA VOLUME 1 PART D2.16 FOR OTHER CLASSES OF BUILDINGS.


N4:

CHECK & CONFIRM ALL DIMENSIONS ON SITE PRIOR TO MANUFACTURING / CONSTRUCTION


MATERIALS & FINISHES SCHEDULE

REFER TO DERBYSHIRE SPECIFICATION FOR COMPLETE SPECIFICATION OF MATERIALS & DETAILS OF FINISH.

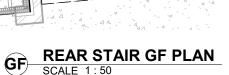

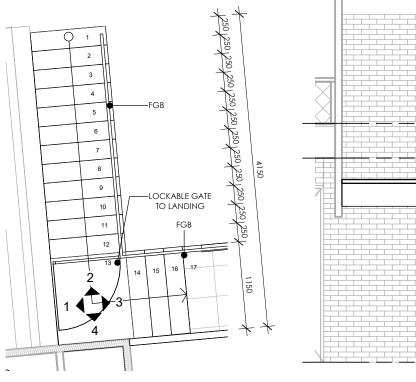



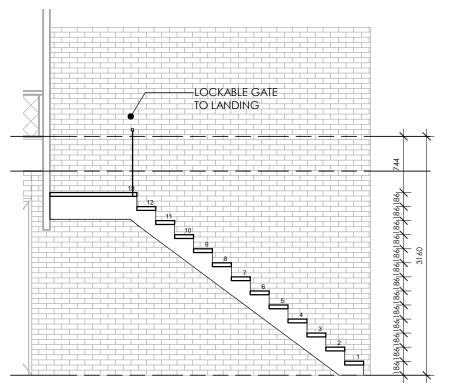

1 REAR STAIR ELEV
SCALE 1:50

ABBREVIATIONS


FGB FRAMELESS GLASS BALUSTRADE

XX DOOR No.


(XX) WINDOW No

 $\langle XX \rangle$


MATERIAL

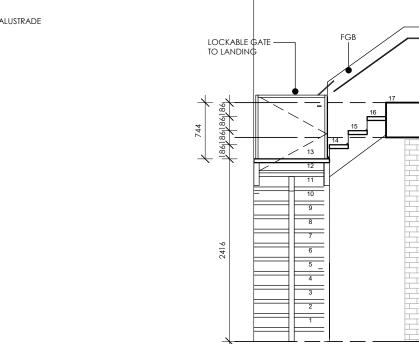



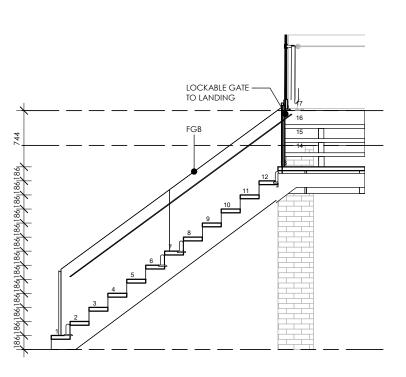



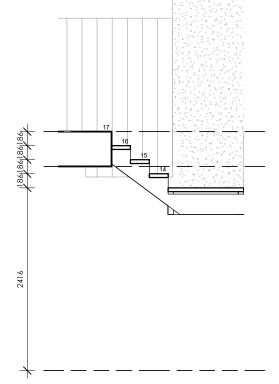

REAR STAIR ELEV

CLIENT

BRENDAN PETER BORG

PROJECT

NOTES

REV DATE

in conjuction with specifications

14.05.19

05.07.19

09.07.19

23.08.19

02.09.19

05.09.19

12.09.19

19.09.19

08.10.19

01.11.19

11.11.19

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CONSTRUCTION ISSUE

LIFT COORDINATION

NGL COORDINATION

17 CALIMO PL

LIFT RELOCATED

BUILDING ENVELOPE

FLOOR SET DOWN

WINDOWS

LIGHT POLE

HEIGHT + WINDOWS ALT

NEIGHBOURS CONSENT ALT

DESCRIPTION

ORIGINAL A3

DRN

ALT

ALT

ALT

ALT

ALT

ALT

LOT 09 (No. 15) CALIMO PLACE INDENTED HEAD 3223

DRAWING

STAIR DETAILS - REAR

Derbyshire

DRAWN	CHECKED	SCALE
ALT	AR	1:50
DATE	PROJECT No	STATUS
1.11.2019	G1811	CD
DRAWING No		REV
A33		

DEVELOPMENT DATA

PROPOSED DATA - NEW RESIDENCE

575,701 M2 61.96 SQ

BUILDING SITE COVERAGE (AREA M2) GROUND FLOOR HOUSE: 143,165 M2 15.41 SQ 109,246 M2 11.76 SQ 41,145 M2 4.42 SQ GARAGE: ALFRESCO: ENTRY DECK: 3,967 M2 0.43 SQ DRIVEWAY: 26,163 M2 2.82 SQ

TOTAL BUILDING AREA: 323,656M2 34.83 SQ

NOTES

THE LOCATION OF SERVICES IS APPROXIMATE ONLY.
BUILDER TO DETERMINE THE EXACT LOCATION OF SERVICES
ON SITE PRIOR TO DEMOLITION

ALL EXISTING SITE LEVELS SHOWN ON THESE DRAWINGS ARE BASED ON SURVEY PLAN PREPARED BY TGM GROUP DWG REF NO. 15084-01-FS01 REV. 1-. DATE OF ISSUE 01.03.2016. BUILDER TO CONFIRM ALL LEVELS ON SITE.

REFER TO ROOF PLAN FOR DETAILS OF ROOFING AND

REFER TO STRUCTURAL ENGINEERS DRAWINGS FOR DETAILS

BUILDER TO ALLOW FOR ALL NECESSARY EXCAVATION, BACKFILLING AND OTHER EARTH MOVING TO RE-ESTABLISH EXISTING GROUND LEVELS EXCEPT WHERE NOTED

LOCATION OF TITLE BOUNDARY IS BASED ON ASSUMPTION

THAT EXISTING FENCES REPRESENT TRUE BOUNDARY. A RE-ESTABLISHMENT SURVEY MAY BE REQUIRED.

MATERIALS & FINISHES SCHEDULE

CARPET

СВ COLORBOND PLASTERBOARD PAINT FINISH RENDERED FOAM

REFER TO DERBYSHIRE SPECIFICATION FOR COMPLETE SPECIFICATION OF MATERIALS & DETAILS OF FINISH.

ABBREVIATIONS

FINISH FLOOR LEVEL RELATIVE LEVEL RAINWATER TANK ELECTRICAL METERBOARD


MW WATER MAIN


INSTANTANEOUS HOT WATER


SWINGIN GATE


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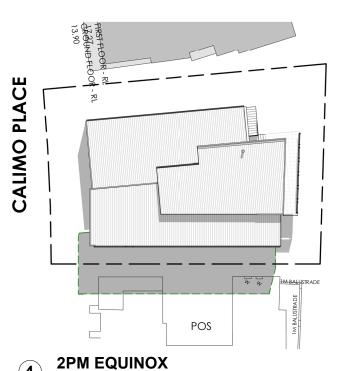
9AM SHADOW @ EQUINOX 12 NOON SHADOW @ EQUINOX
3PM SHADOW @ EQUINOX



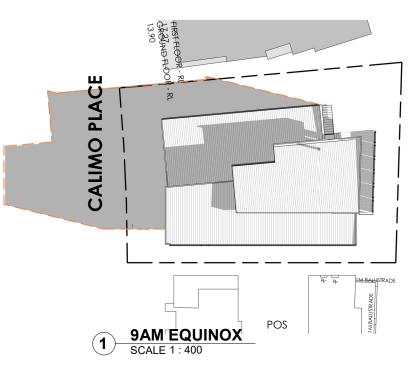

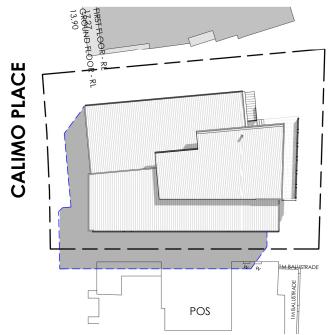

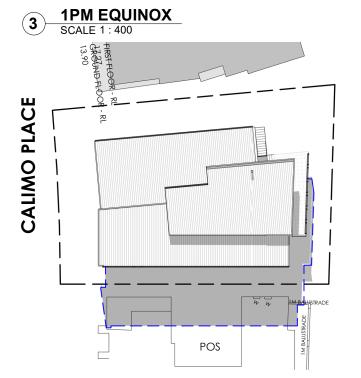

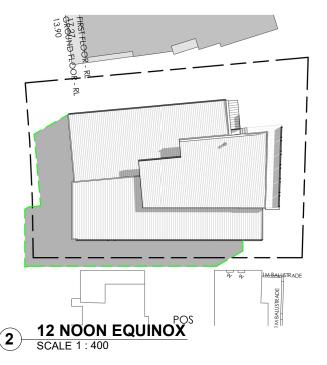

TIME OVERSHADOWING m2/% OF 63m2/100% POS 17 CALIMO PL		WING m2/% OF 63m2/100% POS 17 CALIMO PLACE
9 AM	0%	- COMPLIES
10 AM	0%	- COMPLIES
11 AM	0%	- COMPLIES
12 NOON	7m2/12%	- COMPLIES
1 PM	15m2/24%	- COMPLIES
2 PM	23m2/37%	- COMPLIES
3 PM	33m2/53%	- NOT APPLICABLE AFTER 5 HOURS ESTIMATION ABOVE

3PM EQUINOX SCALE 1:400

SCALE 1:400

NOTES ORIGINAL A3

DO NOT SCALE DRAWINGS - REFER ONLY TO WRITTEN DIMESIONS

Contractor must verify all dimensions and levels on site prior to the commencement of any works, ordering & or manufacture of any

Notify Derbyshire Homes of any discrepancies. Drawings to be read in conjuction with specifications.

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REV	DATE	DESCRIPTION	DRN	CHKD
-	14.05.19	CONSTRUCTION ISSUE	ALT	AR
Α	05.07.19	LIFT COORDINATION	ALT	AR
В	09.07.19	NGL COORDINATION	ALT	AR
C	23.08.19	HEIGHT + WINDOWS	ALT	AR
D	02.09.19	17 CALIMO PL	ALT	AR
Ε	05.09.19	WINDOWS	ALT	AR
F	12.09.19	NEIGHBOURS CONSENT	ALT	AR
G	19.09.19	LIFT RELOCATED	ALT	AR
Н	08.10.19	LIGHT POLE	ALT	AR
1	01.11.19	BUILDING ENVELOPE	ALT	AR
J	11.11.19	FLOOR SET DOWN	ALT	AR

CLIENT

BRENDAN PETER BORG

PROJECT

LOT 09 (No. 15) CALIMO PLACE INDENTED HEAD 3223

DRAWING

SHADOW ANALYSIS

Derbyshire

Address: 98 Pakington St, Geelong West VIC 3218

Phone: (03) 5221 8409

DRAWN	CHECKED	SCALE
ALT	AR	1:250
DATE	PROJECT No	STATUS
1.11.2019	G1811	CD
DRAWING No		REV
A34		



1 OVERLOOKING DIAGRAMS
SCALE 1:200

NOTES ORIGINAL A3

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REV	DATE	DESCRIPTION	DRN	CHKD	
-	14.05.19	CONSTRUCTION ISSUE	ALT	AR	
4	05.07.19	LIFT COORDINATION	ALT	AR	
3	09.07.19	NGL COORDINATION	ALT	AR	
2	23.08.19	HEIGHT + WINDOWS	ALT	AR	
)	02.09.19	17 CALIMO PL	ALT	AR	
	05.09.19	WINDOWS	ALT	AR	
	12.09.19	NEIGHBOURS CONSENT	ALT	AR	
ò	19.09.19	LIFT RELOCATED	ALT	AR	
1	08.10.19	LIGHT POLE	ALT	AR	
	01.11.19	BUILDING ENVELOPE	ALT	AR	
]	11.11.19	FLOOR SET DOWN	ALT	AR	

CLIENT

BRENDAN PETER BORG

PROJECT

LOT 09 (No. 15) CALIMO PLACE INDENTED HEAD 3223



OVERLOOKING DIAGRAMS

Derbyshire

DRAWN	CHECKED	SCALE
ALT	AR	1:200
DATE	PROJECT No	STATUS
1.11.2019	G1811	CD
DRAWING No		REV
A35		